

Willows Planning Commission Regular Meeting Agenda

July 19, 2023, 6:00 pm

Willows City Hall 201 N Lassen Street Willows, CA 95988 Planning Commission
Pedro Bobadilla, Chair
Kellie Burt, Vice Chair
Holly Myers, Commissioner
Maria Ehorn, Commissioner
Llanira Valencia, Commissioner

<u>City Planner</u> Karen Mantele

Minute Clerk

- 1. CALL TO ORDER
- 2. PLEDGE OF ALLEGIANCE
- 3. ROLL CALL
- 4. CHANGES TO THE AGENDA

5. PUBLIC COMMENT & CONSENT CALENDAR FORUM

All matters on the Consent Calendar are considered routine and are approved by one motion and vote unless Commission Members or the City Planner first requests that a matter be removed for separate discussion and action. Individuals wishing to address the Commission concerning Consent Calendar items or regarding matters that are not already on the agenda are invited to make oral comments of up to three minutes at this time. Please address your comments to the Chairman and Commission members, and not to staff and/or the audience. By State law, the Commission is not permitted to undertake any action or discussion on any item not appearing on the posted agenda. If you have any documentation that you would like distributed to the Commission, please mail it to the City Planner at 201 North Lassen Street, Willows, CA 95988 or email it to: kmantele@cityofwillows.org.

a. Minutes Approval

Recommended Action: Approve minutes of the June 21, 2023, Regular Planning Commission Meeting. Contact: Karen Mantele, kmantele@cityofwillows.org

6. PUBLIC HEARING

a. Use Permit File#MUP-23-02 Change of Use from Motel to Multi-Family Residential Apartments and Design Review File#DR-23-0/Site improvements for project.

Recommended Action: Staff recommends Commission receive the staff report, attachments, discuss and upon conclusion, consider the adoption of the attached resolution entitled:

A RESOLUTION OF THE PLANNING COMMISSION OF THE CITY OF WILLOWS APPROVING USE PERMIT (FILE #MUP-23-02) TO MUNISH SHARMA TO ESTABLISH A CHANGE OF USE FROM MOTEL USE TO MULTI-FAMILY RESIDENTIAL USE AND DESIGN REVIEW APPROVAL (FILE #DR-23-02) FOR SITE AND OFF-SITE IMPROVEMENTS FOR PROPERTY LOCATED AT 725 S. TEHAMA STREET, ASSESSORS PARCEL 001-102-009 LOCATED WITHIN THE GENERAL COMMERCIAL ZONING DISTRICT

Contact Karen Mantele, City Planner, kmantele@cityofwillows.org

7. DISCUSSION AND ACTION

a. Request for one- year extension on Design Review File#DR-21-for Jack in the Box Project Recommended Action: Approve request by voice vote.

Contact: Karen Mantele, kmantele@cityofwillows.org

- 8. COMMENTS & REPORTS
 - a. Commission reports/Comments
 - b. Staff Reports/Comments

9. ADJOURNMENT

This agenda was posted on July 14, 2023

Amos Hoover,	City	Clerk

A complete agenda packet, including staff reports and back-up information, is available for public inspection during normal work hours at City Hall or the Willows

Public Library at 201 North Lassen Street in Willows or on the City's website at www.cityofwillows.org.

In compliance with the Americans with Disabilities Act, the City of Willows will make available to members of the public any special assistance necessary to participate in this meeting. If requested, the agenda shall be made available in appropriate alternative formats to persons with a disability, as required by Section 202 of the Americans with Disabilities Act of 1990 (42 U.S.C. Sec. 12132). The public should contact the City Clerk's office at 934-7041 to make such a request. Notification 72 hours prior to the meeting will enable the City to make reasonable arrangements to ensure accessibility to this meeting.

The City of Willows is an Equal Opportunity Provider



PUBLIC COMMENT & CONSENT CALENDAR FORUM



Willows Planning Commission Draft Action Meeting Minutes June 21, 2023

Planning Commission
Pedro Bobadilla, Chair
Kellie Burt, Vice Chair
Llanira Valencia, Commissioner
Holly Myers, Commissioner
Maria Ehorn, Commissioner

1. CALL TO ORDER-6:00 PM

2. PLEDGE OF ALLEGIANCE

Pledge of Allegiance led by Vice Chair Burt

3. ROLL CALL

<u>Commissioners Present:</u> Chair Bobadilla, Vice Chair Burt, Commissioner Myers, Commissioner Ehorn, Commissioner Valencia
<u>Commissioners Absent:</u> None

4. CHANGES TO THE AGENDA

None

5. PUBLIC COMMENT & CONSENT CALENDAR FORUM

No public comments were made.

a. Minutes Approval

Action: Minutes approved for the May 17, 2023, Regular Planning Commission Meetings.

Moved/Seconded: Commissioner Valencia/Commissioner Burt

Yes: Chair Bobadilla, Vice Chair Burt, Commissioner Myers, Commissioner Ehorn, Commissioner

Valencia
No: None
Absent: None

6. PUBLIC HEARING

a. Design Review/File#DR-23-02/Exterior and site improvements for a new business

Open public hearing at 6:12 p.m. Closed public hearing at 6:18 p.m.

<u>Action:</u> Adopted a resolution of the Planning Commission of the City of Willows, granting design review approval (FILE# DR-23-01) to beverage house market for exterior building and site improvements for the property located at 210 W. WOOD STREET, ASSESSORS PARCEL NUMBER 002-142-006/ENTRYWAY ZONE

Moved/Seconded: Commissioner Myers/Commissioner Valencia

Yes: Voice Vote: Chair Bobadilla, Vice-Chair Burt, Commissioner Myers, Commissioner Valencia,

Commissioner Ehorn

No: None Absent: None

7. COMMENTS & REPORTS

- a. Commission Report/Comments
- b. Staff Reports/Comments
 - i. Pat Piatt reported that the owner of the Tower Theatre building is interested in developing the property in a way that would be useful for the community and is soliciting suggestions on what direction to head with it.

8. ADJOURNMENT – 7:03 PM	
	Amos Hoover, City Clerk
	Amos moover, city cierk



PUBLIC HEARING



Date: July 19, 2023

To: Planning Commission

From: Karen Mantele, Principal Planner

Subject: Major Use Permit File#MUP-23-02, Design Review File# DR-23-02/Change of Use

<u>Recommendation:</u> Staff recommends receive the Staff Report, discuss, and upon conclusion, consider adoption of the draft resolution.

Rationale for Recommendation:

Per WMC 18.110.090(8) residential uses are allowed with an approved conditional use permit from the Planning Commission.

Background:

In January of 2023, the applicant Munish Sharma, applied for and was granted a Use Permit to establish a motel use at 725 S. Tehama Street. The property had been previously operated as a motel, however from the time the applicant purchased the property until an application was made, more than six months had elapsed. WMC Section 18.110-090(1) states if a non-conforming use was abandoned for a period of six months or more, subsequent use of the land had to abide by the code for that zoning district. Therefore, the need to apply for a use permit for the motel use was initiated. At the time of taking that use permit application to the Commission, the applicant stated in the future his intentions were to fully convert the building into residential apartment use under Phase 2 and 3 of his plans. The surrounding zoning to the north, south (across canal) and east are the same as the subject parcel, General Commercial. Single-family residential use is west of the subject property and zoned R-1.

Discussion & Analysis:

USE PERMIT:

The proposal is to allow a change of use to an existing commercial structure, from motel use to a multi-family residential use (apartments), consisting of 17 apartments including one standalone building which will be an apartment, used now for the Willows Inn motel reception office.

The change of use is allowed under WMC Section 18.110.090(8) Residential Use Exemption for Existing Structure(s) which states, Existing structure(s) located within the CC (central commercial) or CG (general commercial) zoning districts whether originally constructed as a residential dwelling or not may be allowed for use as residential unit(s) by way of a conditional use permit from the planning commission. No enlargement, extension, reconstruction, or structural alteration may be permitted to the structure except as permitted under subsection (3) of this section. The planning commission is authorized to approve, conditionally approve, or deny a request subject to appeal provisions of WMC 18.135.060. This proposal is Phase 2 of the applicants' overall plan for the site.

The applicants' final goal (Phase 3) is to add three more individual units to add to the apartment use, to be located along the northern side of the property. This addition of three more units will bring the total number of apartments to 20 units. This can be allowed under WMC Section 18.110.090(3)which states: Alterations of Buildings, No existing building designed, arranged, or intended for or devoted to a use not permitted under the regulations of this title for the district in which such building or premises is located shall be enlarged, extended, reconstructed, or structurally altered, unless such use is changed to a use permitted under the regulations specified by this title for such district in which said building is located. However, authorized maintenance shall be permitted not exceeding a total amount (during a period of five years) of 50 percent of the assessed value of the building according to the assessments thereof by the assessor of the county. This addition of one more building with the three separate units referenced will have to be undertaken with a modification to the use permit at a later date.

There will be covered parking for the apartments, including ADA parking, the addition of a trash enclosure to be located on the southern side of the parcel, and off-site improvements to include a sidewalk along Tehama Street. The project site is located within a flood zone, requiring any construction to be compliant with the WMC Floodplain Ordinance.

Additional living units are needed within the city, as the current Housing Element has confirmed, indicating that more types of housing are needed in the area. New businesses are here and coming to the area in the future and the need for housing is increasing. This project will increase the available residential units in demand for the community.

Design Review Analysis:

Competent Design: The carport plans have been designed by an architectural firm. The apartment building is existing and was refinished with the motel use project by adding a new exterior surface.

Relationship Between Structures Within the Development and Between Structures and Site: The building and one separate building for the 17th unit are existing; therefore, the project will fit into the site.

Relationship Between Development and Neighborhood: The addition of a residential use will not be out of character with the neighborhood, as existing SFR uses are located west of the site.

Materials and Colors Used: The carport will be gray color with metal roof and construction.

Utility Service: new electrical service will be installed when the three apartment units are developed.

Lighting: No new lighting is proposed with this Phase as all new lighting for the buildings was installed with the Phase 1 portion of the motel use approval.

Signage: There is an existing double pole sign on the property along Tehama Street. Mr. Sharma obtained a sign permit approval to remove the word "Vacancy" and replace it with the word "Weekly" for motel use. His intentions are to change the pole sign which will require sign permit approval.

Drives, Parking_and_Circulation: 20 covered parking spaces will be constructed as part of the change of use project phase. There are two driveways for ingress/egress into the site, with sufficient width for

emergency vehicles to maneuver. An ADA path of travel will be installed for the trash enclosure and ADA parking space.

Fences/Walls: No fencing is proposed on the site, however there is a wooden fence along the north, south and west property boundaries.

Trash_Enclosure: The proposal for the change of use includes adding an enclosed trash enclosure. **Drainage: All surface/on-site water shall drain properly**. The code states that *Stormwaters shall be removed and carried away in an adequate drainage system. Surface water and all paved areas shall be collected at intervals so that it will not obstruct the flow of vehicles or pedestrian traffic and will not create puddles on the paved areas. The project is conditioned as such within the Engineering conditions.*

Environmental Review:

The project, new construction of a small structure, has been reviewed pursuant to the California Environmental Quality Act (CEQA). City staff has determined that the proposal is exempt from further CEQA pursuant to Section 15301, Class 1, Existing Facilities.

Findings of Fact for use permit approval is required per WMC Chapter 18.135.050. These findings are included in the Draft Resolution.

In accordance with Section 18.135.030 notice of this public hearing was published in the local newspaper ten (10) days prior to the public hearing and all property owners as indicated on the latest secured Assessor's records within 400 feet of the subject property were sent notice of the hearing. As of the date of preparation of this report no written or verbal public comments have been received.

Fiscal_Impact:

A PTA is on deposit for the processing of the applications.

Attachments:

- 1. Draft Resolution
- 2. Draft Conditions of Approval
- 3. Applicant Phasing Plan
- 4. Carport images
- 5. Architectural Plan
- 6. Zoning/General Plan map





PC RESOLUTION NO. XXX-2023

A RESOLUTION OF THE PLANNING COMMISSION OF THE CITY OF
WILLOWS APPROVING USE PERMIT (FILE #MUP-23-02) TO MUNISH SHARMA
TO ESTABLISH A CHANGE OF USE FROM MOTEL USE TO MULTI-FAMILY RESIDENTIAL USE AND DESIGN
REVIEW APPROVAL (FILE #DR-23-02) FOR SITE AND OFF-SITE IMPROVEMENTS FOR PROPERTY
LOCATED AT 725 S. TEHAMA STREET, ASSESSORS PARCEL 001-102-009 LOCATED WITHIN THE GENERAL
COMMERCIAL ZONING DISTRICT

WHEREAS the applicant Munish Sharma, has filed a Conditional Use Permit application for a change of use from motel use to establish a multi-family residential use, and,

WHEREAS Section 18.110-090(8) allows for residential uses within the CG zoning district with Planning Commission approval of a Use Permit; and

WHEREAS the applicant has filed a Design Review application for site improvements under WMC Section 18.141, and,

WHEREAS notices of the Planning Commission meeting held on July 19, 2023, were published in a newspaper of general circulation in the City in accordance with law, and mailing to property owners within 400 feet were sent; and,

WHEREAS the Planning Commission did, on July 19, 2023, hold a public hearing to consider all public oral and written comments, letters and documents, staff reports, and all other documents and evidence which are a part of the Record; and,

WHEREAS the Planning Commission has reviewed all evidence submitted in connection with the application, including public testimony, staff report, supporting documentation, City codes and regulations, and all other relevant documents and evidence which are part of the record of proceedings; and,

WHEREAS the Planning Commission finds that the use proposal is considered exempt from the California Environmental Quality Act (CEQA) pursuant to Section 15301, Class 1, Existing Facilities, and

WHEREAS the Planning Commission does find that the proposed use is consistent with the purposes of the district in which the site is located, as WMC Section 18.110.090(8) allows for residential use in the General Commercial zoning district with an approved use permit; and,

WHEREAS the Planning Commission does find that the proposed location of the use and the conditions under which it may be operated or maintained will not be detrimental to the public health, safety, or welfare or materially injurious to properties or improvements in the vicinity, as the zoning district allows for residential uses and, conditions of approval have been included to ensure the safety and welfare of the public are met; and

WHEREAS the Planning Commission does find that the proposed use is in conformance with the General Plan, as the property is located within the General Commercial designation, which allows for residential uses.

NOW THEREFORE, BE IT RESOLVED, that the Planning Commission of the City of Willows does hereby find that the Use Permit proposal to allow a change of use from motel use to multi-family residential use, is consistent with the City of Willows General Plan, the City of Willows Municipal Code, and hereby approves Use Permit FILE #MUP-23-02, and Design Review FILE #DR-23-02, subject to the attached conditions of approval set forth in Attachment #2.

IT IS HEREBY CERTIFIED that the foregoing Resolution was duly adopted at a regular meeting of the Planning Commission of the City of Willows on Wednesday, the 19th day of July 2023 by the following vote:

AYES
NOES
ABSTAIN
ABSENT

APPROVED:

ATTESTED:

Amos Hoover, City Clerk

Pedro Bobadilla, Chairperson

Major Use Permit FILE# MUP-23-02 & Design Review File# DR-23-02 CONDITIONS OF APPROVAL for Change of Use Project FOR PROPERTY LOCATED at

725 S. Tehama Street /APN: 001-102-009 PC approval date: ______, 2023

General:

- That the applicant/developer shall enter into a Pass-Through Agreement with the City of Willows to pay the cost of all planning review, plan checking and field inspection of this development.
- 2. All contractors performing construction on the project site shall obtain a city business license.
- 3. If the use (multi-family residential use) is not made on the project subject to the permit within one (1) year after the date of granting the permit, then without further action, the permit shall be null, and void and such use shall not be made of the property except upon the granting of a new permit.
- 4. The Architectural Design Review approval shall expire in one year unless otherwise stipulated by the Planning Commission. The applicant may apply to the city manager or his/her designee for an extension of not more than one year from the original date of expiration, if he finds that there has been no substantial change in the factual circumstances surrounding the originally approved design. Substantial changes and any further extension beyond one year shall require Planning Commission approval. Any further extension beyond one year shall require planning commission approval.
- 5. The developer shall adhere to the design presented for Architectural Design Review approval, regarding new carports, trash enclosure, off-site improvements, and roadway surfacing.
- 6. Parking for residential use shall be provided per the WMC parking regulations prior to use, including installation of covered carports as shown on the architectural plans submitted for this change of use project.
- 7. Any changes to pole sign or new signage shall require sign permit approval from the Planning Department prior to installation.

Building Department

- 8. The proposed development shall be designed and constructed in accordance with the most current applicable Building Codes, including the Uniform Building Code (UBC) and the California Building Code (CBC) as determined by the Building Department of the City of Willows.
- 9. All work shall comply with current Federal, State and Local codes and ordinances, and be shown on the plans submitted for review.
- 10. The parcel is within a special flood hazard AH on FEMA's Flood Insurance Rate map with a base flood elevation of 131. All work shall comply with the WMC Floodplain ordinance.
- 11. The final adopted conditions of approval for this Design Review approval and the adopted final conditions of approval for the Use Permit shall be on the plans submitted for review.
- 12. Routes from the proposed ADA parking stalls to the proposed ADA units shall be via walkways that meet ADA accessible paths of travel.

Engineering/Public Works Department:

General Conditions:

- 13. Developer shall design and construct all improvements and facilities shown on any approved tentative map, site plan, or other documents submitted for permit approval, in accordance with the Willows Municipal Code (WMC), the City of Willows Design and Construction Standards.
- 14. The developer shall be responsible for all City plan check, map check and inspection costs. The developer shall deposit funds with the City upon the initiation of plan check services. The amount of the initial deposit shall be determined by the City Engineer. Additional funds may be required based upon actual plan check and inspection costs.
- 15. All existing overhead utilities serving the existing site shall be placed underground. This does not include surface mounted transformers, pedestal mounted terminal boxes and meter cabinets.

Improvement Plan and Construction Conditions:

- 16. Improvement plans shall be prepared and submitted by a California Registered Civil Engineer for the construction of all necessary and required on-site and off-site improvements including grading, water, sanitary sewer, storm drain facilities, roadway improvements, curbs, gutters, sidewalks, parkway strips and streetlights. All design and construction shall conform to the City of Willows Design and Construction Standards, as applicable.
- 17. A detailed Soils Investigation/Geotechnical Report shall be prepared and submitted for review for all new structures planned on the site and/or for substantial modifications to existing structures that impact the foundation. The report shall address, at a minimum, potential for liquefaction, expansive soils, and seismic risk. The improvement plans shall incorporate all design and construction criteria recommended in the Geotechnical Report.
- 18. If the existing pool is filled in with dirt, compaction on the soil should be at least 90% relative compaction and observed by a soils engineer to verify that it was done property. All pool equipment, drain lines and fill lines shall be disconnected and either capped or completely removed.
- 19. Improvements plans shall include a storm water pollution prevention plan.
- 20. All driveways, parking lots and aisleways shall be paved to provide a non-yielding solid weatherproof surface sufficient to support emergency vehicles (minimum of 6-inches of class 2 road base and 2-inches of asphalt.) The actual paving section shall be included in the soils report for the site but shall not be less than specified herein. Any existing pavement that is damaged shall be repaired or replaced to meet the standards of this condition.
- 21. Roadway Improvements:
 - a. The existing gutter fronting the northerly portion of the property along S. Tehama Street shall be extended southerly to the southerly property line.
 - b. The applicant shall install sidewalk along the entire frontage of the property. Sidewalk construction shall be per City Standards and shall make provision to ensure compliance with ADA standards, particularly where the sidewalk crosses the two driveways, the utility pole and the fire hydrant fronting the property. If the sidewalk has to be warped around any existing feature such that it causes the sidewalk to go beyond the right-of-way line, the applicant shall provide a public access easement in favor of the City of Willows in locations where the sidewalk goes beyond the existing right-of-way.
 - c. Ramps for disabled persons meeting the most recent standards shall be provided at all intersections and at the limits of the improvements where they do not adjoin existing

sidewalk improvements. Sidewalk warps shall be provided as necessary to allow a clear four-foot-wide walkway at all locations, including areas where mailboxes, streetlights, and fire hydrants obstruct sidewalks.

22. Water and Sanitary Sewer Improvements:

- a. The applicant shall have the sewer lateral serving the site inspected to ensure it is in acceptable condition. The inspection shall be done via CCTV and shall meet the criteria as established by the City with respect to acceptable pipe condition. If it is discovered that the sewer lateral serving the property does not meet acceptable standards, the applicant shall cause repairs to be made to the pipe to bring the condition of the pipe into acceptable condition.
- b. The applicant shall prove that the finished floors are a minimum of 12" above upstream sewer manhole or clean-out rim elevations. Inadequate elevation differentials or grade on private laterals, as determined by the city, must be mitigated by either raising finished floor elevation(s), installing backflow prevention devices, or installing privately owned and operated sewer lift station(s) with grinder/ejector pump(s) on site.
- c. A trash enclosure shall be constructed with the project that shall include a sump to collect any liquid, runoff, or rainwater from the trash area. The sump shall be pumped as needed and shall not be connected to either the storm drain system or the sewer system (unless there is a cover over the trash enclosure that would prevent rain runoff from getting to the sump. If a cover is put over the trash area, the sump can be connected to the City's sewer system.)

23. Drainage Improvements:

a. All project related flooding impacts shall be mitigated by the project developer. Drainage improvements shall be designed in accordance with the Design Criteria utilizing the rationale method and any applicable adopted City drainage plans.

The applicant shall submit for review and approval, drainage plans and hydraulic calculations prepared by a Registered Civil Engineer. The drainage plans and calculations shall indicate the following conditions before and after development:

Quantities of water, water flow rates, major water courses, drainage areas and patterns, diversions, collection systems, flood hazard areas, sumps, and drainage courses.

- b. Post-development off-site flows shall not exceed pre-development flows.
- c. The property associated with this development is shown to be in Special Flood Hazard Zone AH on FEMA's Flood Insurance Rate Map with a base flood elevation of 131. The applicant must either demonstrate that the existing structures on the site are in compliance with the Section 15.65.050 of the City's Municipal Code with respect to floodproofing or provide plans showing how the development of this site will meet floodproofing requirements.


Construction Conditions:

- 24. No construction shall be performed until the improvement plans have been approved and signed by the City Engineer. Encroachment Permits and Building Permits will not be issued prior to the approval of the improvement plans. An Encroachment Permit is required for any work within the City's rights of way.
- 25. The developer shall keep adjoining public streets free and clean of project dirt, mud, materials, and debris during the construction period, as is found necessary by the City Engineer.
- 26. If construction activity will result in a land disturbance of one acre or larger, the developer shall provide evidence that a Notice of Intent has been submitted and received by the Regional Water Quality Control Board for a General Construction Activity Storm Water Permit. A copy of the project Storm Water Pollution Protection Plan shall be submitted to the City.
- 27. If any hazardous waste is encountered during the construction of this project, all work shall be immediately stopped and the Glenn County Environmental Health Department, the Fire Department, the Police Department, and the City Inspector shall be notified immediately. Work shall not proceed until clearance has been issued by all of these agencies.
- 28. Where soil or geologic conditions encountered in grading operations are different from that anticipated in the soil and/or geologic investigation report, or where such conditions warrant changes to the recommendations contained in the original soil investigation, a revised soil or geologic report shall be submitted for approval by the City Engineer. It shall be accompanied by an engineering and geological opinion as to the safety of the site from hazards of land slippage, erosion, settlement, and seismic activity. Additionally, if field conditions warrant installation of any subdrains, the location, size and construction details must be provided to the City for review and approval prior to construction.
- 29. All streets, curbs, gutters, or other public facilities damage in the course of construction associated with this development shall be the responsibility of the Developer and shall be repaired to the satisfaction of the City at the Developer's expense.
- 30. Dust control must be maintained to the City's satisfaction.
- 31. Working hours shall be restricted to the hours of 7:00 a.m. to 6 p.m., Monday through Friday.
- 32. The overhead electrical service from the pole onto the property should be placed underground.

Release of Securities Conditions:

- 33. All improvements shown on the Improvement Plans shall be completed and accepted by the City.
- 34. All punch-list work shall be completed, and any outstanding inspection fees or other charges shall be paid.
- 35. Developer shall provide sufficient surety guaranteeing the public improvements for a period of one year.
- 36. A complete set of *As-Built* or Record improvement plans showing all substantial changes from the original plans shall be certified by the Civil Engineer of record and submitted to the City Engineer prior to acceptance of the public improvements.
- 37. Prior to acceptance of the work, the developer shall provide a written statement signed by his or her engineer certifying that they observed the work during construction and that site grading and all private site improvements have been completed in accordance with the improvement plans approved by the City Engineer.

Attachment 3

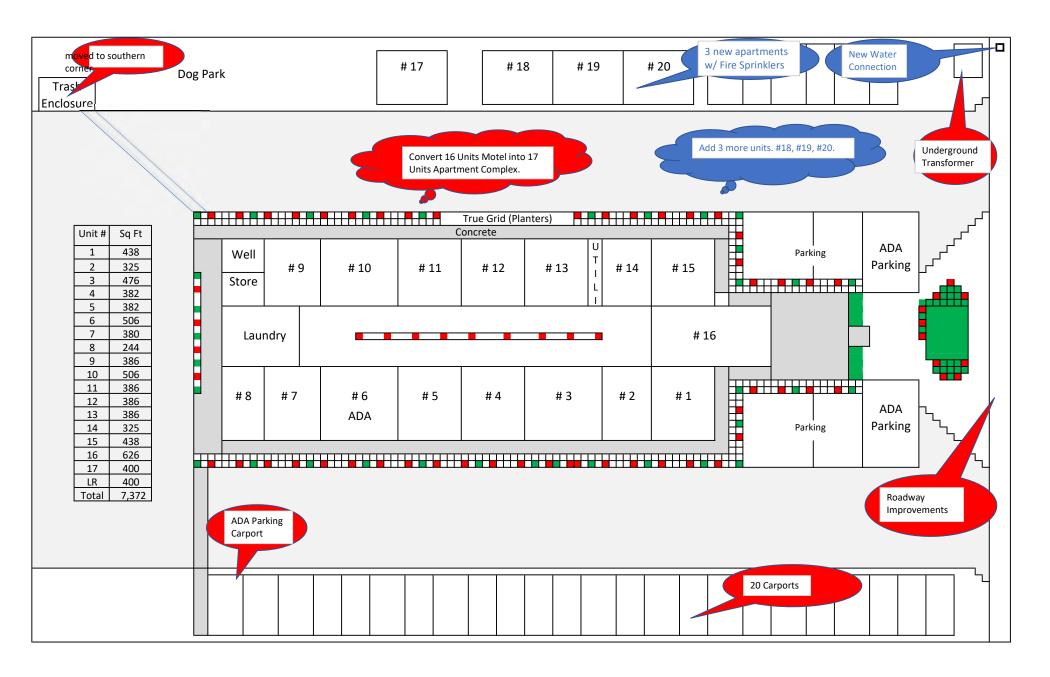





WILLOWS APARTMENTS **BUILDING INFORMATION GENERAL INFORMATION ADA FUNDING** LAND/BUILDING OWNER MUNISH SHARMA RISK CATEGORY CBC TBL 1604.5 THIS PROJECT WILL NOT RECEIVE FUNDING FROM **725 SOUTH TEHAMA STREET** jaimacproperties||c@gmail.com PUBLIC SOURCES, INCLUDING TAX CREDITS AND WILL CONSTRUCTION SITE ADDRESS 725 SOUTH TEHAMA STREET **WILLOWS, CA 95988** BE PRIVATELY FUNDED R-2/U(SHADE STRUCTURE) WILLOWS, CA 95988 OCCUPANCY EXISTING CONDITIONED AREA PRIOR TO CONSTRUCTION <u>10,536 SQFT</u> CHANGE OF OCCUPANCY FROM SCOPE OF WORK ALL ITEMS R-1 MOTEL TO R-2 EXISTING UNLESS APARTMENTS. USE PERMIT FIRE SPRINKLERS OTHERWISE NOTED REQUIRED. CONDITIONS PER (1) SHADE STRUCTURE 4,160 SQFT **720 S. BUTTE ST.** 719 S. TEHAMA ST CITY MEMORANDUM INCLUDES: **(E) 4-PLEX** 20' 011-020-500 011-020-160 1. COVERED CARPORTS FOR **DESIGN CRITERIA** EACH REQUIRED STALL PER **ZONE: R-1 ZONE: CG** PARKING ANALYSIS **ESMNT** RUN NEW UG ELECTRICAL TO 110 ELM - ST 2. NEW ELECTRICAL NONE PROVIDED GEOTECHNICAL REPORT TRANSFORMER TRANSFORMER TO POWER 011-020-180 16-UNIT APARTMENT AND 1,500 PSF ALLOW. SOIL BEARING PRESSURE NEW PG&E PAD MOUNTED FUTURE 3-PLEX ALLOW. LAT. BEARING PRESSURE 100 PSF/FT TRANSFORMER TO BE **ZONE: CG** LOCATED AT SAME HEIGHT GAS METER-FUTURE UNITS 3. ACCESSIBILITY 130 PSF ALLOW. COHESION -PER SEPARATE COMPLIANCE FOR PARKING PERMIT -6' BLDG SETBACK AND PATH OF TRAVEL **WIND** 110 MPH/ 87 ASD WIND (3 SEC GUST) 4. PAVING AT CARPORTS EXPOSURE NEW SERVICE ENTRANCE 5. NEW CURB, GUTTER, SE PER SHEET E1.1 SIDEWALK AT FRONTAGE OF **UNIT 17 SEISMIC** LOT PER CITY OF WILLOWS STANDARDS GOVERNING CODES 2019 CA BUILDING CODE 2019 CA GREEN BUILDING CODE FUTURE SIDEWALK 2019 CA ENERGY CODE 2019 CA ELECTRICAL CODE 2019 CA FIRE CODE 2" AC GRINDINGS **FUTURE 1-1/2"** 2019 CA PLUMBING CODE RISK FACTOR OVER 2" GRAVEL WATER LINE TO-2019 CA MECHANICAL CODE NEW UG ELEC IMPORTANCE FACTOR FUTURE UNITS PER E SHEETS CITY OF WILLOWS MUNICIPAL CODE SITE CLASS PERMITTING AGENCY CITY OF WILLOWS DESIGN CATEGORY EQUIV LATERAL FORCE **SITE INFORMATION** ANALYSIS PROCEDURE ASSESSOR'S PARCEL NO. **TESTING & SPECIAL** ZONING ROOF MOUNT WELL ROOM **ELEC ROOM INSPECTION** PARCEL ACREAGE _HVAC Ø.8 ACRE THE FOLLOWING TESTS AND INSPECTIONS SHALL BE (E) FENCE T WATER FF=131.00 16-UNIT APARTMENT PERFORMED BY AN INDEPENDENT TESTING LABORATORY BE REMOVED SEWAGE DISPOSAL EMPLOYED BY THE OWNER AND APPROVED BY THE BUILDING OFFICIAL. TEST AND INSPECTION REPORTS SHALL BE WILDLAND URBAN INTER. SUBMITTED FOR APPROVAL TO THE STRUCTURAL ENGINEER PER CRC R337 AND THE BUILDING OFFICIAL, CONFORMING TO THE OVERHEAD NATURAL GAS AVAIL -POWER TO BE REMOVED SITE ELEVATION (ASL) RESPONSIBILITY OF THE CONTRACTOR TO INFORM THE GROUND SNOW LOAD (E) COVERED WORKING DAY PRIOR TO PERFORMING ANY WORK THAT WALKWAY REQUIRES SPECIAL INSPECTION. ALL WORK PERFORMED FLOOD ZONE DESIGNATION ZONE AH (EL 131) 06021C0614D WITHOUT REQUIRED SPECIAL INSPECTION IS SUBJECT TO 10,536 / 34,848 = 30% FLOOR AREA RATIO ☐ ENGINEERED FILL COMPACTION TESTS. **SPECIAL FEATURES** ROOF MOUNT SOLAR PANELS TO REMAIN. ACCESSIBLE ☐ PILES, DRILLED PIERS AND CAISSONS. Y—FIRE HYDRANT HERS DUCT TESTING CO.I * * * PANELS+TO REMAIN* * * * CONCRETE TESTS CYLINDERS, F'C EXCEEDING 2500 psi. **730 ELM ST** PLACE 36" X 30" ADA ENERGY CERT OF COMP PATH TO TRASH-☐ STRUCTURAL MASONRY, F'M = COMPLIANT COLOR CONTRASTING ENCLOSURE W/ 4" REINFORCEMENT, GROUT, AND ANCHOR RODS. 011-020-490 -DETECTABLE WARNING TACTILE STRIPING ▼ PROVIDE 4' ROOF RAFTER INSULATION WHEN ADA PATH CROSSES ☐ STRUCTURAL STEEL WELDING AS REQUIRED BY WELDING STRIPED ADA **ZONE: R-1** VEHICULAR WAY PATH OF TRAVEL 2" HOT MIX COOL ROOF PLACE 4" CONCRETE ENCLOSURE CO.1 ASPHALT OVERLAY **CARPORT** -W/ #4 BARS EACH STRUCTURAL STEEL HIGH STRENGTH ANCHOR RODS O/ EXISTING AC (20) PROPOSED COVERED_ WAY @24" OC (A325 OR A490). PARKING STALLS ☐ STRUCTURAL GLUED-LAMINATED TIMBER, DURING ☐ EMBEDDED ITEMS (EPOXY INSTALLED ANCHORS, WEDGE ANCHORS, ETC...) NO SPECIAL INSPECTIONS REQUIRED. PARKING ANALYSIS PARKING REQUIREMENTS ARE PER CH. 18.120 OF WILLOWS MUNICIPAL CODE BLDG (CO.1) FOR MULTIFAMILY DWELLINGS, PROVIDE ONE COVERED PARKING SPACE FOR EACH UNIT CONTAINING ONE BEDROOM. 16 UNITS PROPOSED, 1 EXISTING; 26 PARKING SPACES PROVIDED LEVEE ACCESS ROAD **UNIT AREA SUMMARY** 3 ADA PARKING STALL PER CH. 18.120.040 OF WILLOWS MUNICIPAL CODE. 3 VAN STALLS PROVIDED **438 SQFT 325 SQFT 476 SQFT UNIT 4 382 SQFT** SITE PLAN **382 SQFT** UNIT 5 WELL **506 SQFT** UNIT 10 | UNIT 11 | UNIT 12 | UNIT 13 | **DEFERRED SUBMITTALS** UNIT 14 UNIT 15 **380 SQFT** DEFERRED SUBMITTALS **244 SOFT UNIT 8** SHALL FIRST BE SUBMITTED TO AUSMUS ENGINEERING FOR REVIEW & COORDINATION. FOLLOWING THE COMPLETION OF THE REVIEW AND COORDINATION A SUBMITTAL MAY THEN BE MADE TO THE BUILDING DEPARTMENT FOR REVIEW AND UNIT 10 **506 SOFT UNIT 16 LAUNDRY OPEN COURTYARD** APPROVAL, WHICH SHALL INCLUDE A LETTER STATING THIS REVIEW UNIT 11 **386 SÕFT** AND COORDINATION HAS BEEN PERFORMED AND COMPLETED. **386 SQFT** NONE UNIT 13 **386 SQFT SHEET INDEX** UNIT 14 **325 SQFT** COVERSHEET & SITE PLAN UNIT 5 UNIT 4

UNIT 3 UNIT 2 UNIT 1

1"=20'

UNIT 8 UNIT 7 | 1 UNIT 6

ADA

2 ROOM KEY

UNIT 15

UNIT 16

UNIT 17

438 SQFT

626 SQFT

400 SQFT

391 SQFT

PH: (530) 521-2648 EMAIL: ERIC@ AUSMUSENGINEERING.COM

EDGE OF

PAVEMENT

CONSTRUCT 4' WIDE

SIDEWALK TO

CO.1/SIGN

GRADING DRAINAGE & EROSION CONTROL

ELECTRICAL SYMBOLS & SPECIFICATIONS

ELECTRICAL SCHEDULES AND SINGLE LINE DIAGRAM

CIVIL SITE DETAILS

CARPORT CANOPY

PANEL SCHEDULES

PANEL SCHEDULES

SITE ELECTRICAL PLAN


OVERALL ELECTRICAL PLAN


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EØ.3

EØ.4

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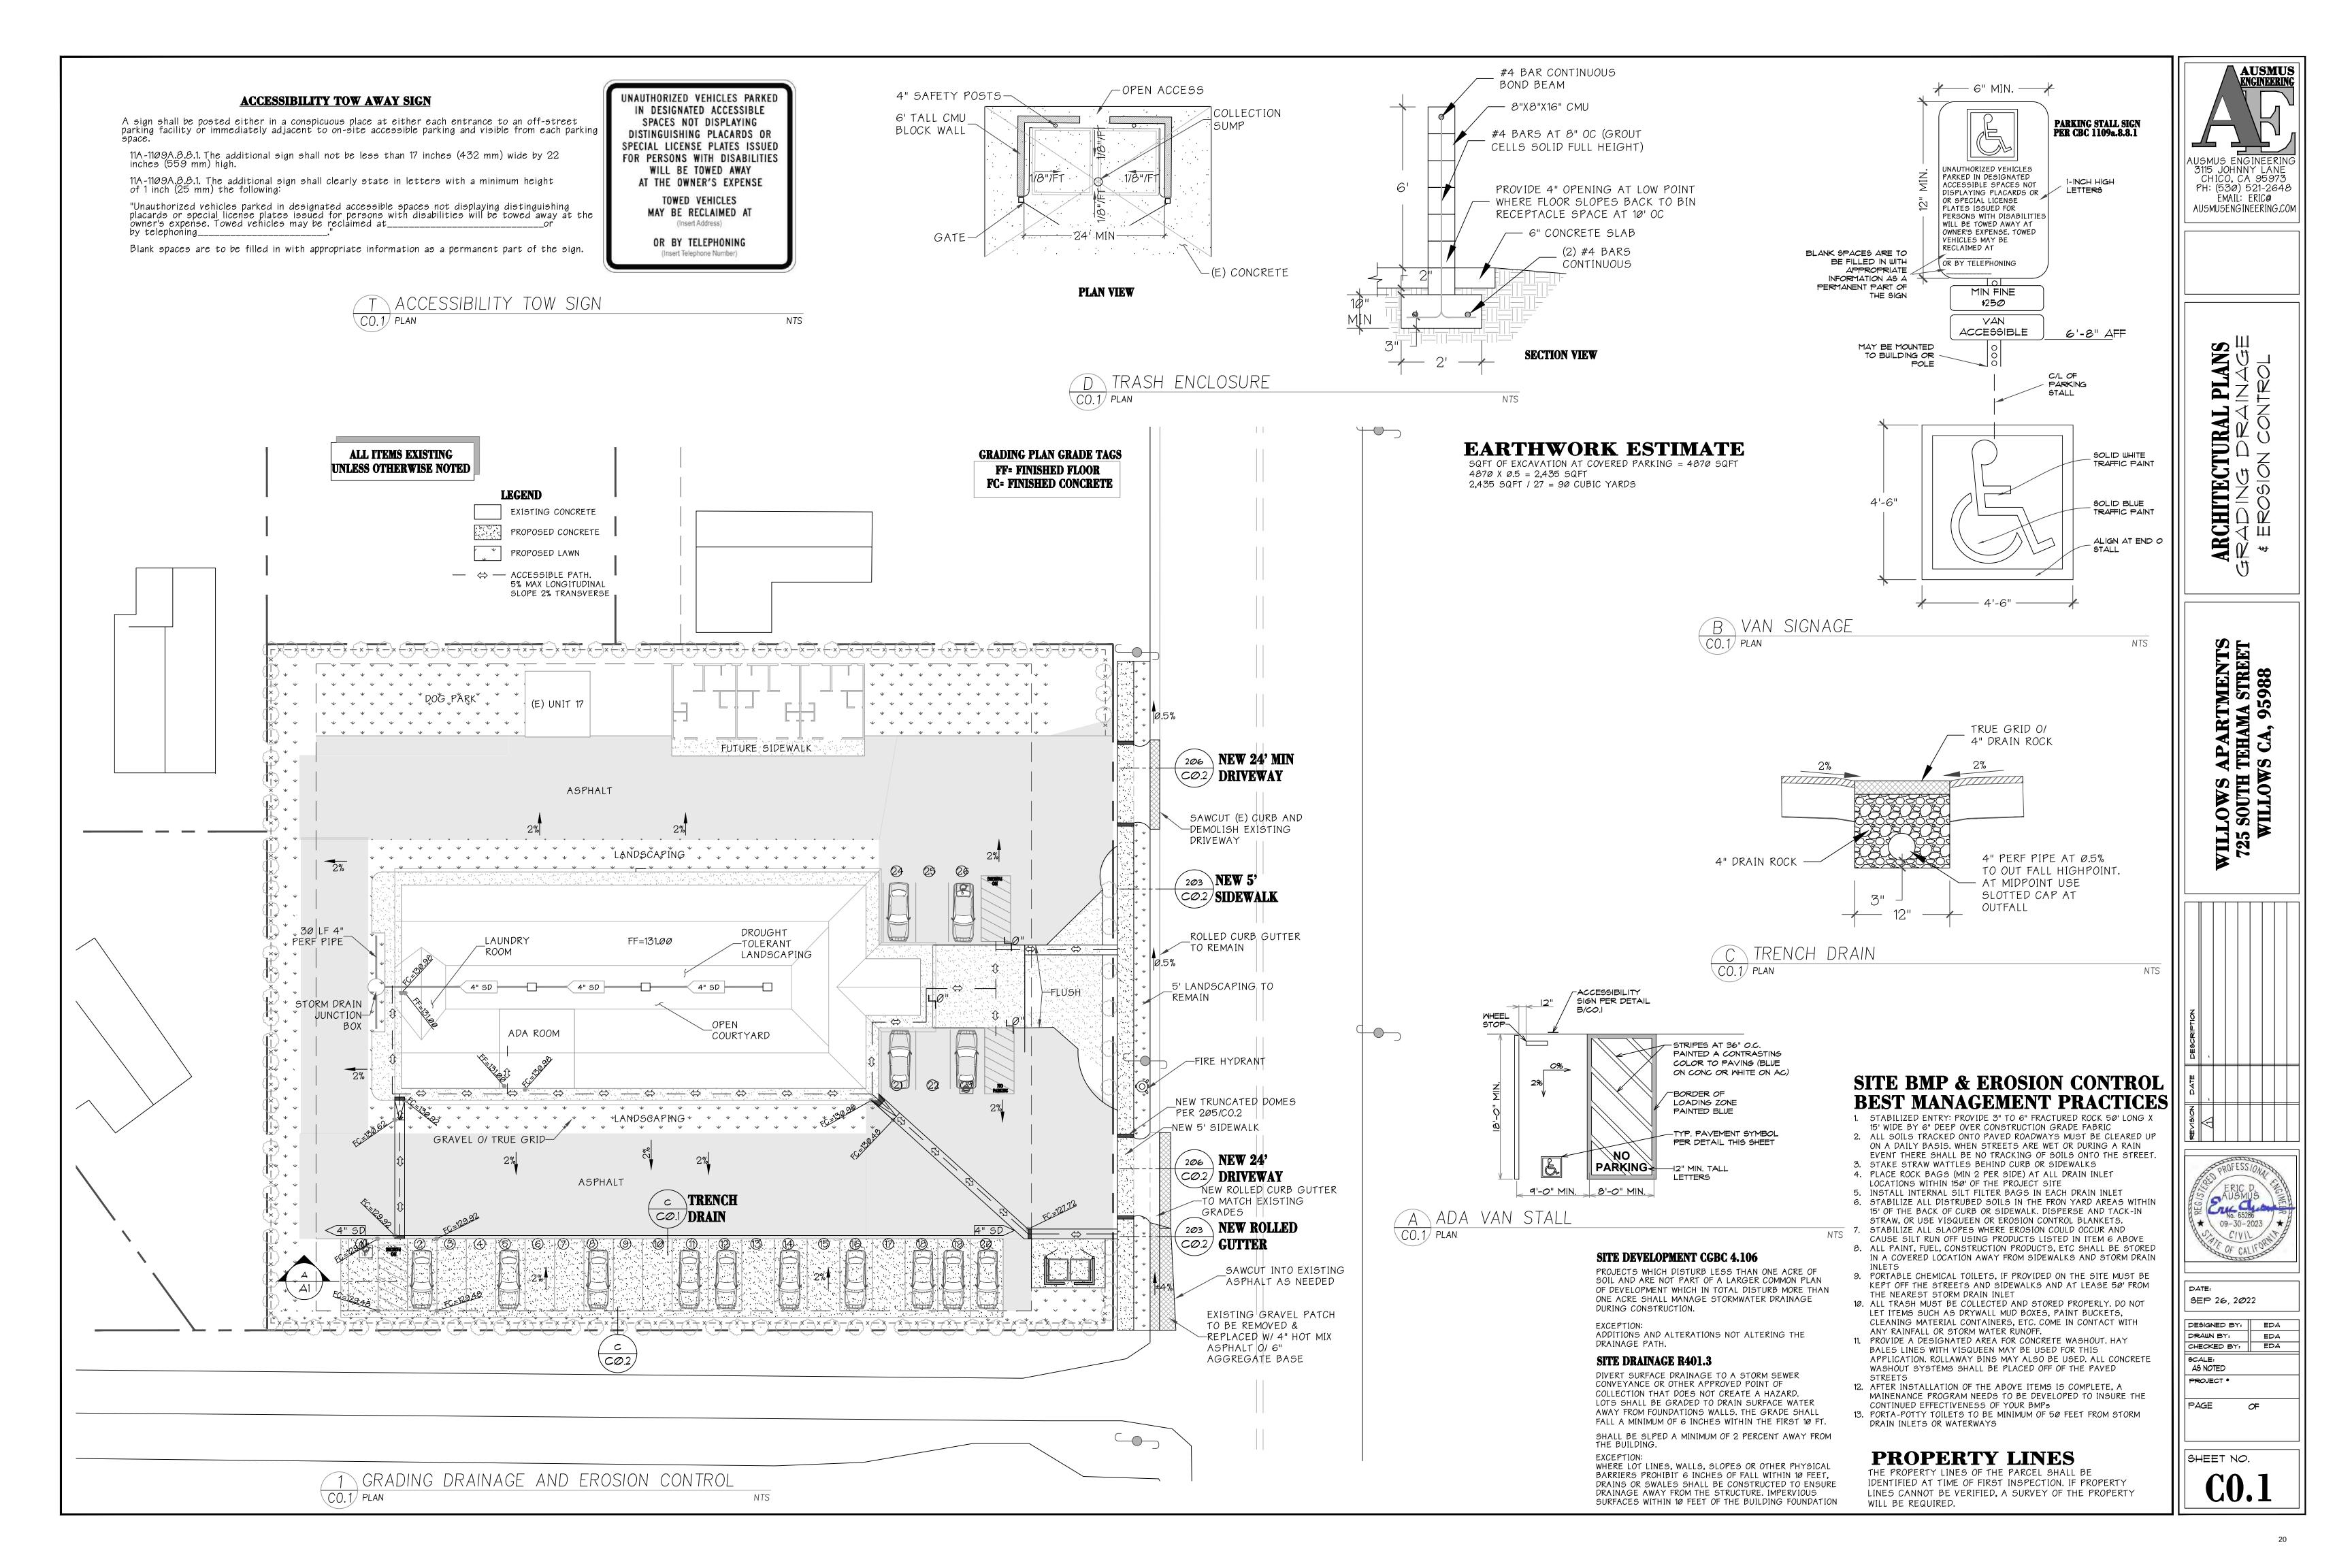



SEP 26, 2022 DESIGNED BY: EDA DRAWN BY: EDA

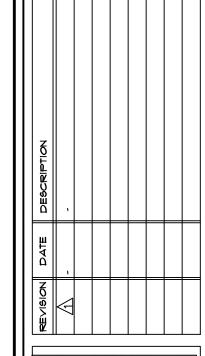
CHECKED BY: EDA AS NOTED PROJECT *

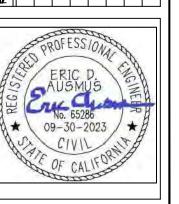
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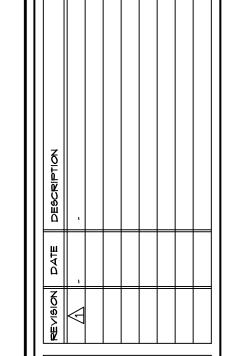





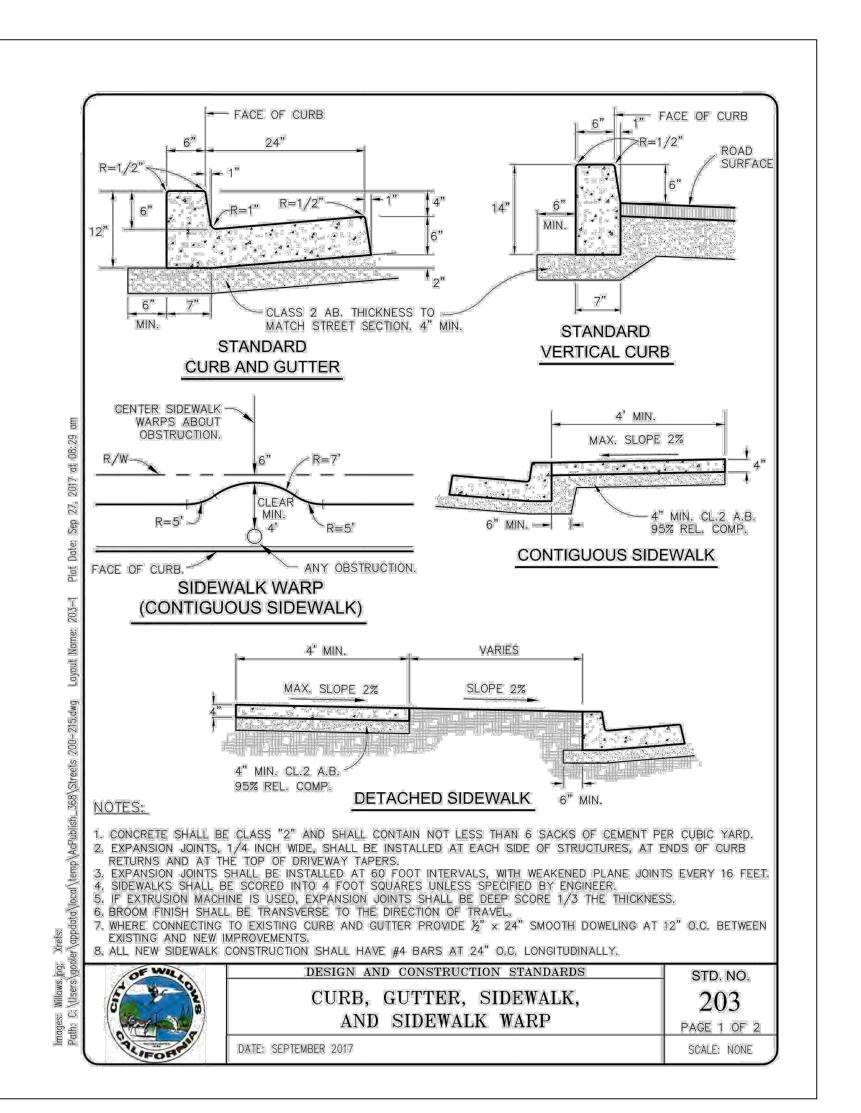

HTECTURAL PLAN

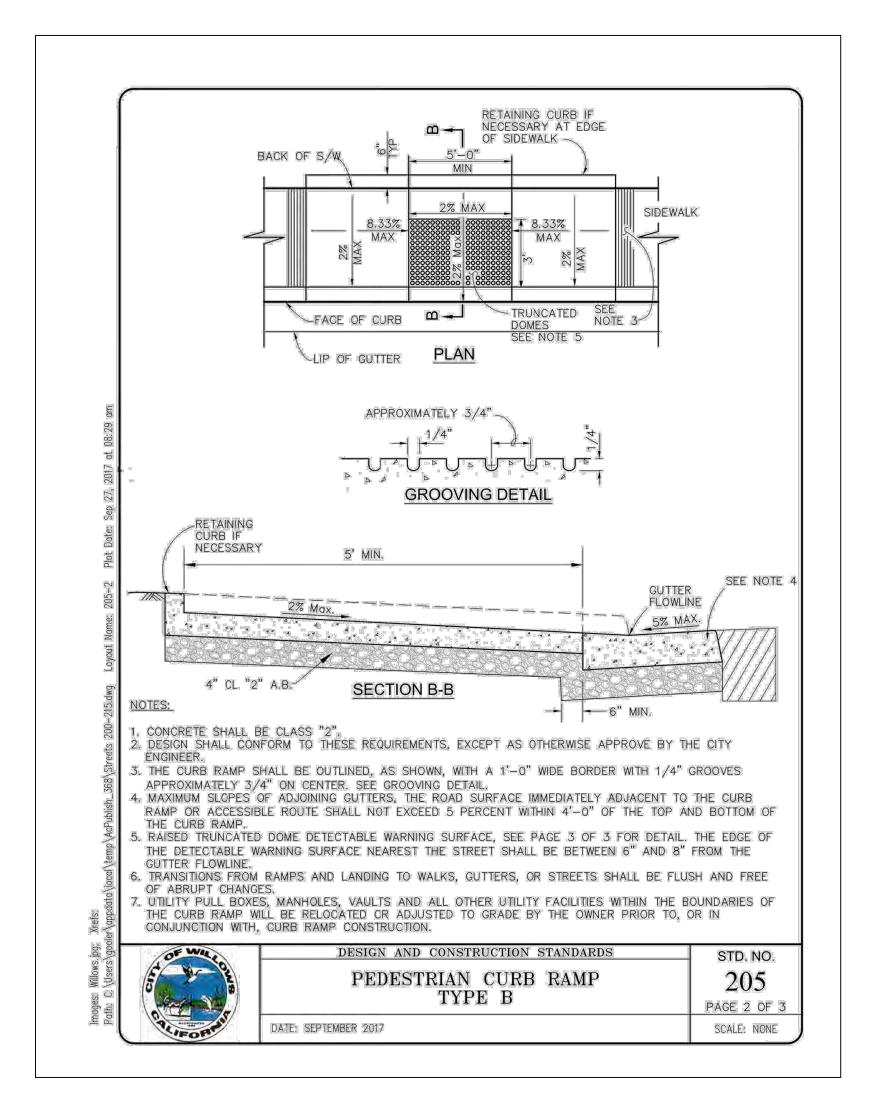ILLOWS APARTMENTS
25 SOUTH TEHAMA STREET
WILLOWS CA, 95988

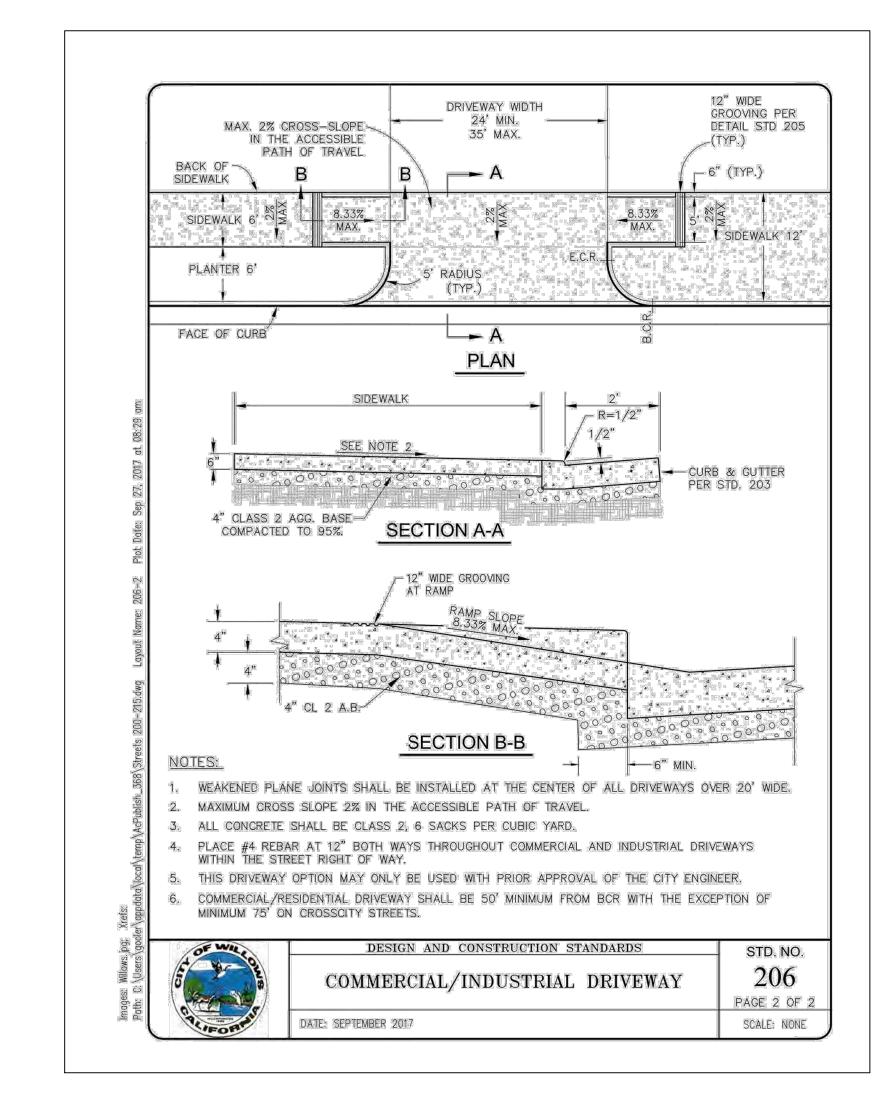

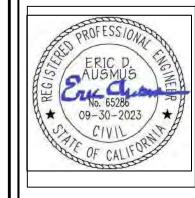


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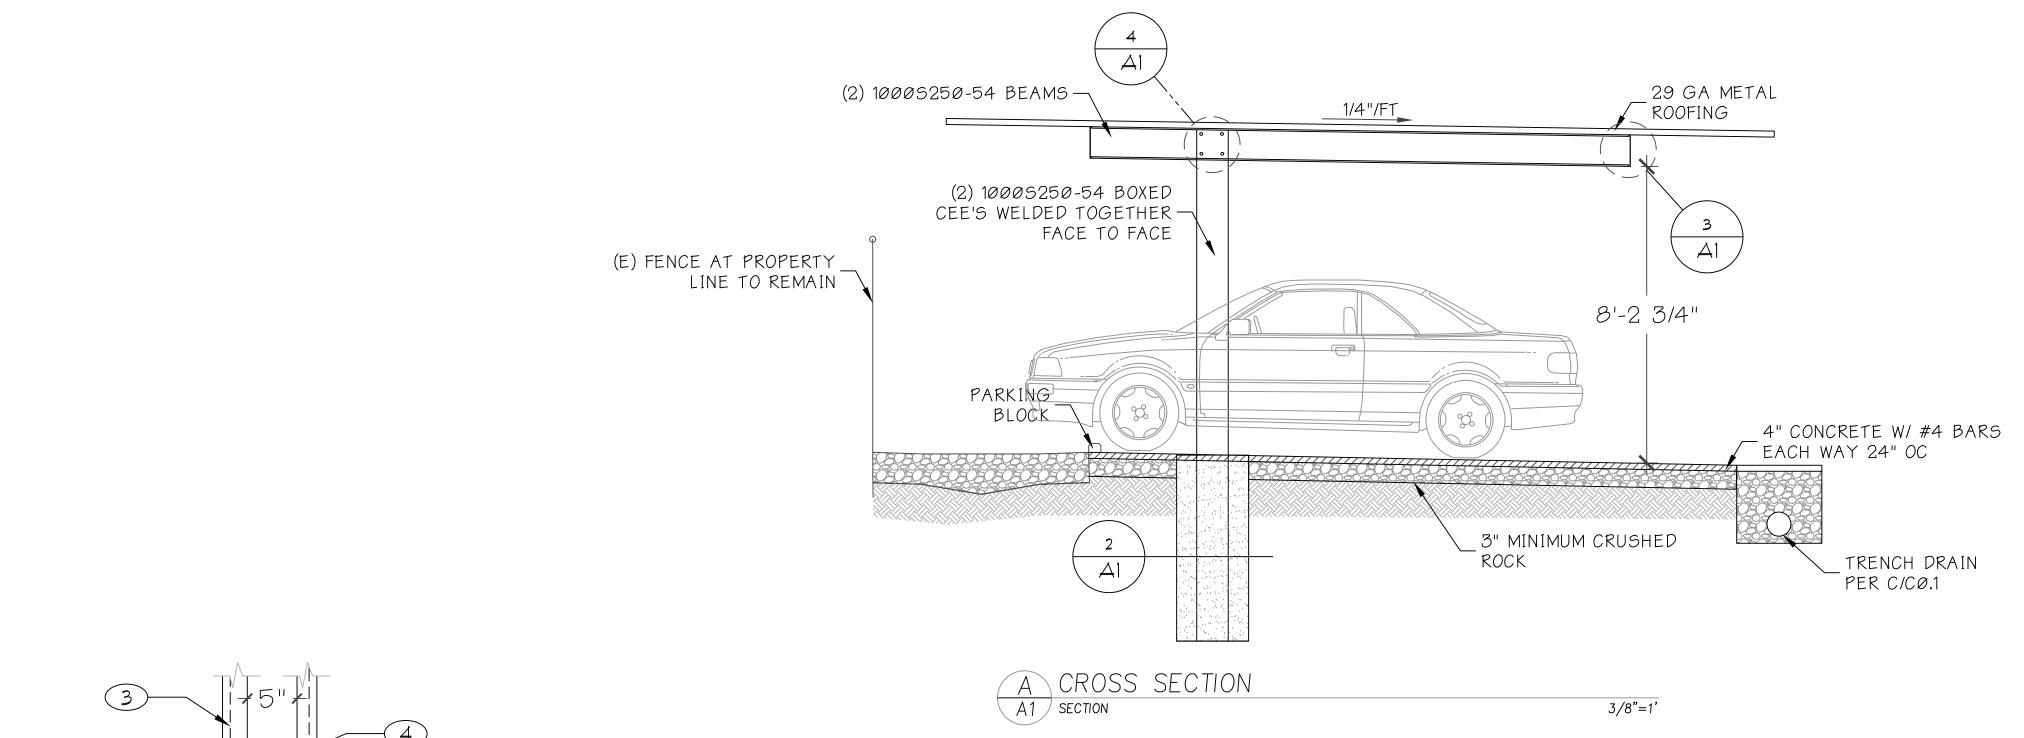
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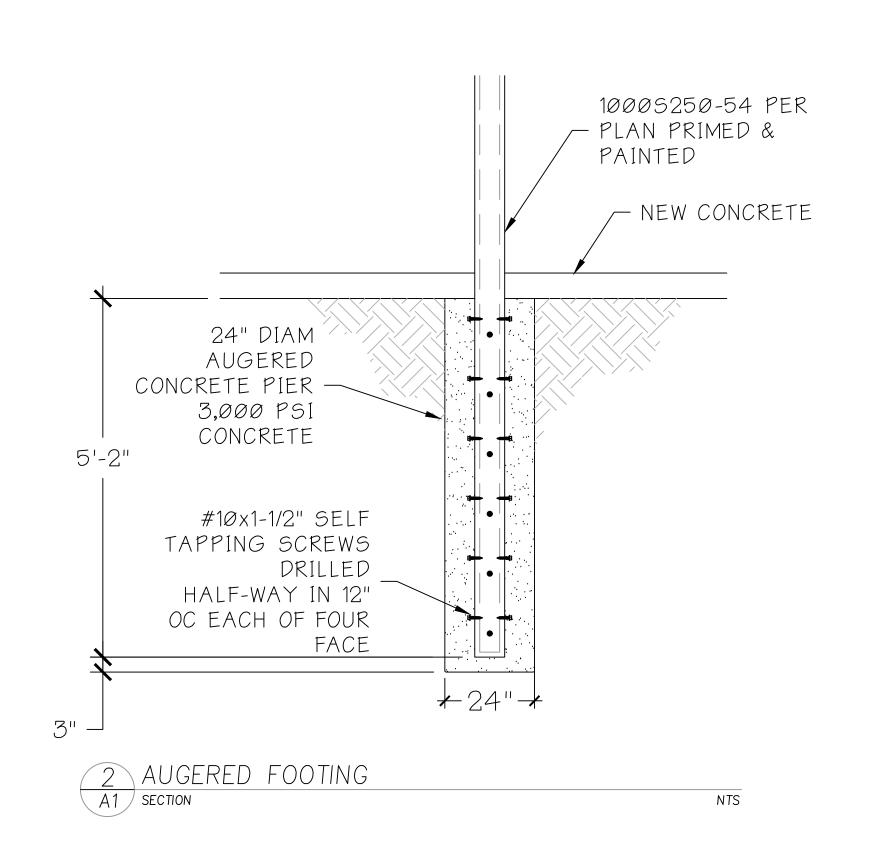
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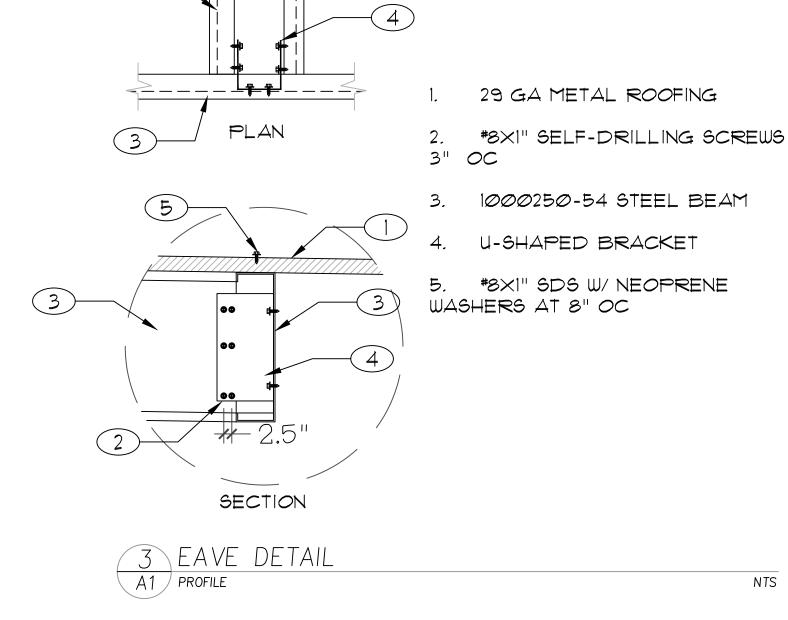
CO.2










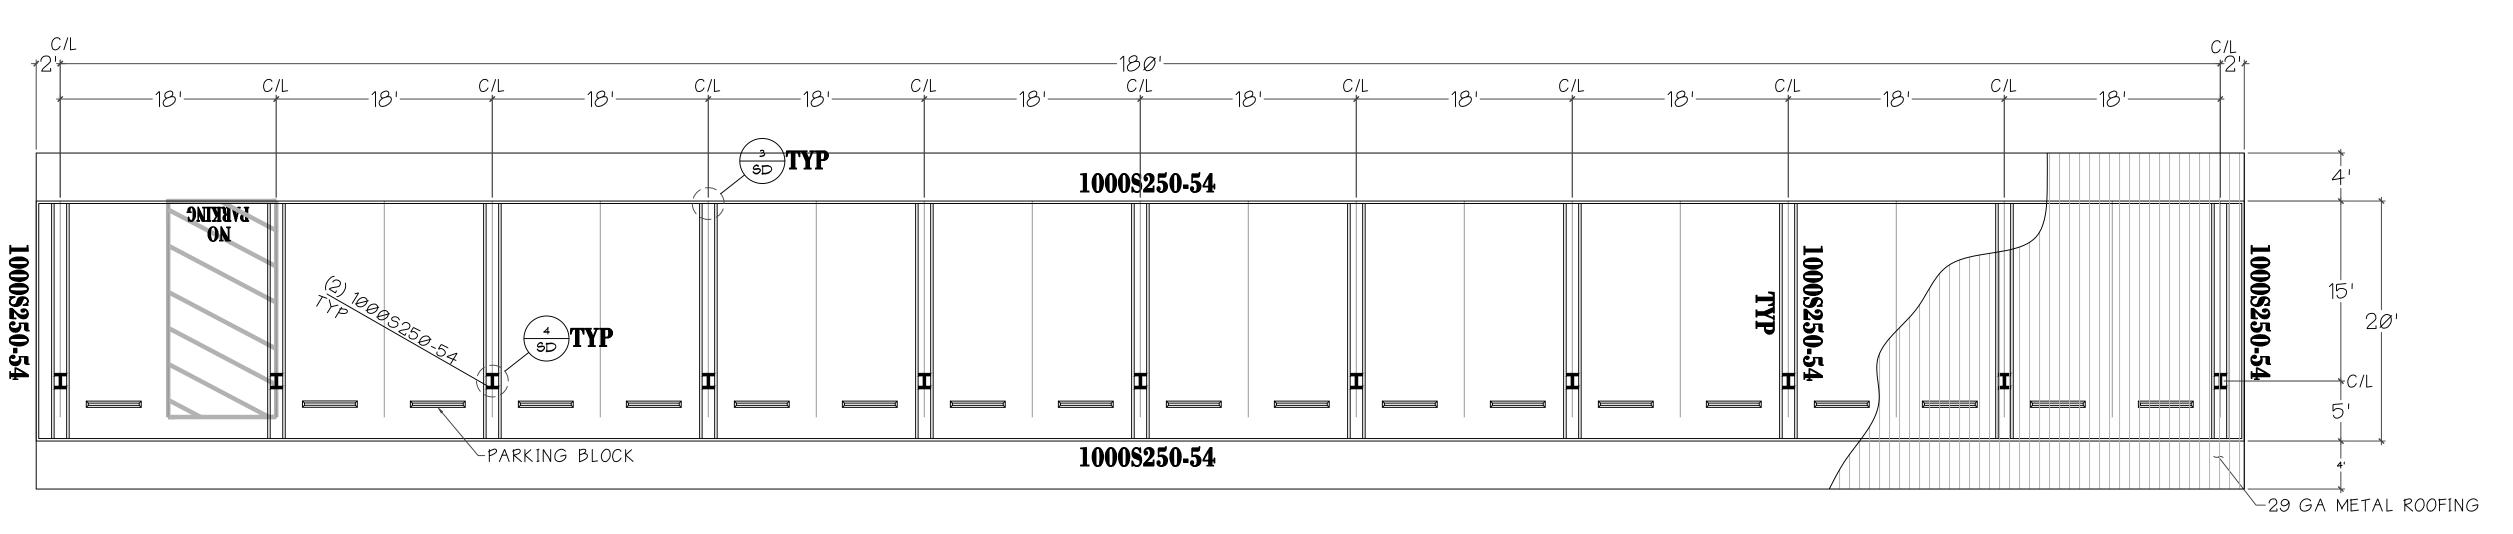

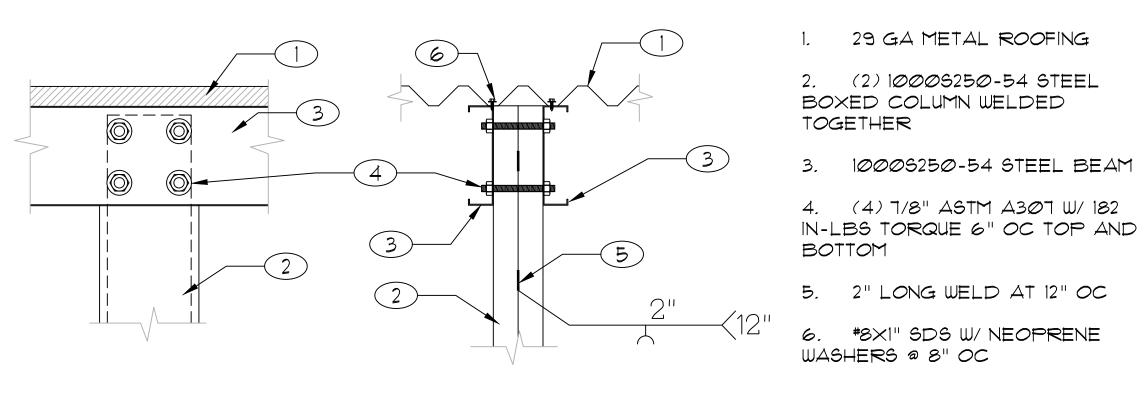


A1 SECTION


WASHERS @ 8" OC 4 AUGERED FOOTING

NTS

AUSMUS ENGINEERING 3115 JOHNNY LANE CHICO, CA 95973 PH: (530) 521-2648 EMAIL: ERICO AUSMUSENGINEERING.COM

ARCHITECTURAL PLANS

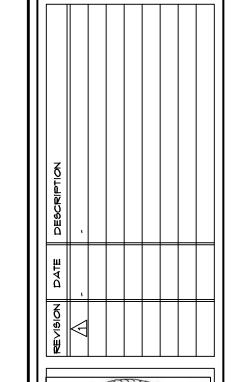

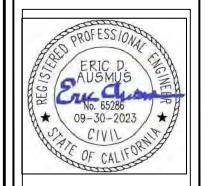

SEP 26, 2022

29 GA METAL ROOFING

#8×1" SDS W/ NEOPRENE

DESIGNED BY: EDA
DRAWN BY: EDA CHECKED BY: EDA AS NOTED PROJECT *


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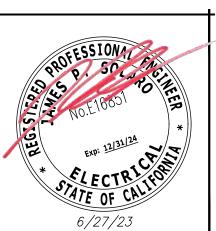
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	SPECIFICATIONS SPECIFICATIONS						
ITEM	DESCRIPTION	ITEM	DESCRIPTION				
26.1	STANDARDS AND CODES: ALL ELECTRICAL WORK SHALL BE PERFORMED IN ACCORDANCE WITH THE 2017 EDITION OF THE NATIONAL ELECTRICAL CODE (NEC), CALIFORNIA ELECTRICAL CODE (CEC), NATIONAL FIRE CODE (NFPA 70 E), OSHA, ALL APPLICABLE STATE AND LOCAL CODES AND ORDINANCES. THIS DOES NOT RELIEVE THE CONTRACTOR FROM FURNISHING AND INSTALLING WORK SHOWN OR SPECIFIED WHICH MAY EXCEED THE REQUIREMENTS OF SUCH ORDINANCES, LAWS, REGULATIONS AND CODES.	26.17	CIRCUITING: ALL WIRING SHALL BE IN CONDUIT, MINIMUM 3/4"C, CONCEALED EXCEPT WHERE NOTED. EMT WITH STEEL SET SCREW INSULATED—THROAT FITTINGS MAY BE USED IN DRY, PROTECTED INTERIOR LOCATIONS. PVC SCHEDULE 40 SHALL BE USED BELOW GRADE AT MINIMUM —24". WRAPPED RIGID ELBOWS AND RISERS SHALL BE USED FOR ALL THROUGH—GRADE TRANSITIONS AND STUB—UPS. RGS OR IMC CONDUIT WITH THREADED FITTINGS SHALL BE USED IN ALL LOCATIONS WHERE EXPOSED TO THE ELEMENTS				
26.2	<u>COMPLETE INSTALLATION</u> : PROVIDE ALL LABOR, MATERIALS, EQUIPMENT, TOOLS, ACCESSORIES, ETC., NECESSARY TO ACCOMPLISH A COMPLETE ELECTRICAL SYSTEM IN ACCORDANCE WITH THE PLANS TOGETHER WITH THE SPECIFICATIONS.		OR SUBJECT TO PHYSICAL DAMAGE. METAL—CLAD CABLE (TYPE MC) IS ACCEPTABLE FOR; FLEXIBLE WHIPS FROM JUNCTION BOXES TO LIGHTING FIXTURES (NO LONGER THAN 6—FEET IN LENGTH). TYPE MC CABLE MAY NOT BE USED IN ANY OTHER LOCATIONS. ENT IS NOT ALLOWED. CONNECT RECESSED AND SUSPENDED LIGHTING FIXTURES, MOTORIZED AND VIBRATING EQUIPMENT WITH STEEL FLEX. ALL CONDUIT SHALL HAVE PULL CORD IF OTHERWISE EMPTY. ROMEX OR TYPE SER CABLE MAY BE UTILIZED IN THE				
26.3	<u>PERMITS:</u> OBTAIN AND PAY FOR ALL BUILDING AND WORKING PERMITS AND INSPECTION FEES REQUIRED FOR THIS PROJECT.	26.18	RESIDENTIAL PORTION OF THE PROJECT <u>ONLY</u> . <u>WIRING</u> : WIRE SHALL BE COPPER UNLESS OTHERWISE INDICATED. MINIMUM WIRE SIZE SHALL BE #12 AWG.				
26.4	<u>DRAWINGS</u> : DATA PRESENTED ON THESE DRAWINGS SHALL BE FIELD VERIFIED SINCE ALL DIMENSIONS, LOCATIONS, AND LEVELS ARE GOVERNED BY ACTUAL FIELD CONDITIONS. REVIEW ALL ARCHITECTURAL, STRUCTURAL, CIVIL, MECHANICAL AND SPECIALTY SYSTEMS DRAWINGS AND ADJUST ALL WORK TO MEET	26.19	INSULATION SHALL BE THW, THWN OR THHN. FUSES: FUSES SHALL BE SIZED PER ACTUAL NAMEPLATE OF EQUIPMENT SERVED. FUSES SHALL BE				
	THE REQUIREMENTS ON CONDITIONS SHOWN THEREON, DO NOT SCALE ELECTRICAL PLANS FOR FIXTURE, DEVICE OR APPLIANCE LOCATIONS. USE CONFIGURED DIMENSIONS IF GIVEN OR CHECK ARCHITECTURAL OR MECHANICAL DRAWINGS.		DUAL-ELEMENT, CURRENT-LIMITING, AND SHALL BE INTERCHANGEABLE BETWEEN FRAME SIZES WITH STANDARD FACTORY FUSE REDUCERS. FUSES SHALL BE AS FOLLOWS UNLESS OTHERWISE INDICATED:				
26.5	<u>COPYRIGHT:</u> THESE PLANS, SPECIFICATIONS AND ALL RELATED ADDENDA AND DOCUMENTS CONSTITUTE COPYRIGHT MATERIALS OF JP ENGINEERING. ALL RIGHTS CONFERRED BY THE COPYRIGHT AND SIMILAR LAWS ARE RESERVED TO JP ENGINEERING. THESE MATERIALS SHALL REMAIN THE SOLE PROPERTY OF JP		CIRCUITS 601 TO 6000 AMPERES SHALL BE PROTECTED BY CURRENT LIMITING BUSSMANN LOW-PEAK TIME-DELAY FUSES KRP-C - UL CLASS L CIRCUITS 0 TO 600 AMPERES SHALL BE PROTECTED BY CURRENT LIMITING BUSSMANN LOW-PEAK				
	ENGINEERING AND MAY NOT BE REPRODUCED, DISTRIBUTED TO OTHERS OR USED FOR ANY PURPOSE WHATSOEVER WITHOUT THE PRIOR WRITTEN CONSENT OF JP ENGINEERING.		DUAL-ELEMENT FUSES LPN-RK (250 VOLTS) OR LPS-RK (600 VOLTS) - UL CLASS RK1				
26.6	<u>LOCATIONS</u> : INDICATED LOCATIONS OF ALL OUTLETS AND EQUIPMENT ARE SUBJECT TO CHANGE. SHIFT/RELOCATE/RECONFIGURE ANY OUTLET, EQUIPMENT OR CONNECTION POINT UP TO 10' AS DIRECTED BY ENGINEER, AT NO ADDED COST.		ALL INDIVIDUAL MOTOR CIRCUITS RATED 480 AMPERES OR LESS SHALL BE PROTECTED BY BUSSMANN LOW-PEAK DUAL-ELEMENT FUSES LPN-RK (250 VOLTS) OR LPS-RK (600 VOLTS)-UL CLASS RK1 OR L				
26.7	RECORD DRAWINGS: CONTRACTOR SHALL PROVIDE, PRIOR TO FINAL ACCEPTANCE AND OBSERVATION, ONE SET OF REVISED RECORD ELECTRICAL CONSTRUCTION DOCUMENTS ON REPRODUCIBLE MEDIUM INDICATING THE FOLLOWING ADDITIONAL INFORMATION:		CIRCUIT BREAKER PANELS SHALL BE PROTECTED BY BUSSMANN LOW—PEAK DUAL—ELEMENT FUSES LPN—RK (250 VOLTS), LPS—RK (600 VOLTS) OR BUSSMANN LOW—PEAK KRP—C TIME—DELAY FUSES — UL CLASS RK1 OR L				
	EXACT ROUTING OF ALL CONDUITS LARGER THAN 1" EXACT LOCATION OF ALL SERVICE GROUNDING/BONDING CONNECTIONS CONTRACTORS NAME, ADDRESS AND TELEPHONE NUMBER		ALL DUAL-ELEMENT FUSES SHALL HAVE SEPARATE OVERLOAD AND SHORT-CIRCUIT ELEMENTS. PROVIDE SPARE FUSE CABINET AFTER THE COMPLETION OF THE PROJECT WITH ONE SET OF SPARE FUSES FOR EVERY SIZE USED.				
	RECORD NOTATIONS SHALL BE CLEARLY DRAWN AT A DRAFTING APPEARANCE EQUAL TO THE ORIGINAL DRAWINGS. CONTRACTOR SHALL ALSO PROVIDE ALL OPERATING AND MAINTENANCE MANUALS PRIOR TO FINAL PAYMENT.	26.20	<u>UTILITY SERVICES:</u> PROVIDE POWER AND COMMUNICATIONS SYSTEM SERVICES IN ACCORDANCE WITH THE REQUIREMENTS OF THE SERVING UTILITIES. PROVIDE EXCAVATION, RACEWAY, STRUCTURES, GROUNDING, ETC. AS REQUIRED. CONTACT SERVING UTILITIES AND OBTAIN THEIR PROJECT SPECIFIC REQUIREMENTS PRIOR TO BID. UTILITY WORK INDICATED HEREIN IS FOR BIDDING ASSISTANCE ONLY. THESE PLANS DO NOT PURPORT TO INDICATE ALL WORK REQUIRED. (UTILITY SERVICE CHARGES PAID BY OTHERS).				
26.8	EXAMINATION OF SITE AND EXISTING CONDITIONS: BEFORE SUBMITTING A PROPOSAL, CONTRACTOR SHALL EXAMINE THE SITE AND FAMILIARIZE HIMSELF WITH THE EXISTING CONDITIONS AND LIMITATIONS. NO EXTRAS WILL BE ALLOWED BECAUSE OF THE CONTRACTOR'S MISUNDERSTANDING OF THE AMOUNT OF WORK INVOLVED OR HIS LACK OF KNOWLEDGE OF ANY SITE CONDITIONS WHICH MAY AFFECT HIS WORK. ANY APPARENT VARIANCE OF THE DRAWINGS OR SPECIFICATIONS FROM THE EXISTING CONDITIONS AT THE	26.21	TEMPORARY CONSTRUCTION POWER: PROVIDE TEMPORARY ELECTRICAL POWER AND LIGHTING FOR ALL TRADES THAT REQUIRE SERVICE DURING THE COURSE OF THIS PROJECT. PROVIDE TEMPORARY SERVICE AND DISTRIBUTION AS REQUIRED. COMPLY WITH THE NEC AND OSHA REQUIREMENTS. (ENERGY COSTS BY OTHERS).				
26.9	SITE SHALL BE CALLED TO THE ATTENTION OF THE ENGINEER BEFORE SUBMITTING A PROPOSAL. TESTING: PRIOR TO PLACING IN SERVICE, ALL ELECTRICAL SYSTEMS SHALL BE TESTED FOR OPENS, GROUNDS, AND PHASE ROTATION. THE MAIN SERVICE GROUND AND ALL LOCAL TRANSFORMER MADE	26.22	<u>SUBMITTALS</u> : BEFORE ORDERING ANY EQUIPMENT, CONTRACTOR SHALL SUBMIT ELECTRONIC PDF COPIES OF FACTORY SHOP DRAWINGS FOR ALL LIGHTING FIXTURES, SWITCHGEAR, PANELS, MOTOR CONTROLLERS, WIRING DEVICES, ETC. PROPOSED FOR THIS PROJECT.				
26.10	GROUNDS SHALL BE MEGGER—TESTED. PROVIDE GFI TESTING FOR SERVICE SWITCHBOARD. GROUNDING: GROUND ALL EQUIPMENT AND SYSTEM NEUTRAL IN ACCORDANCE WITH ARTICLE 250 OF THE NEC. EQUIPMENT GROUNDS HAVE NOT BEEN SHOWN ON DRAWINGS — WHERE GROUND WIRES HAVE BEEN SHOWN THEY INDICATE AN INSULATED GROUND.	26.23	<u>SUBSTITUTIONS:</u> PROPOSED SUBSTITUTIONS SHALL BE EQUAL OR SUPERIOR TO SPECIFIED ITEMS IN ALL RESPECTS. DETERMINATION OF EQUALITY RESTS SOLELY WITH ENGINEER. SUBSTITUTIONS MUST BE SUBMITTED A MINIMUM OF 10 WORKING DAYS PRIOR TO BID FOR CONSIDERATION. PROPOSED SUBSTITUTIONS PROVIDED LATER WILL NOT BE REVIEWED OR ALLOWED. BID SUBSTITUTED MATERIAL WILL ONLY BE ALLOWED IF ACCEPTED IN WRITING BY ENGINEER.				
26.11	<u>EQUIPMENT STANDARDS</u> : ALL MATERIALS AND EQUIPMENT SHALL BE NEW AND OF THE HIGHEST QUALITY AVAILABLE ("SPECIFICATION GRADE"). SERVICE EQUIPMENT SHALL BE FACTORY—ASSEMBLED COMMERCIAL—GRADE, CONFIGURED PER SERVING UTILITY STANDARDS. WIRING DEVICES SHALL BE SPECIFICATION GRADE WITH NYLON PLATES, WHITE UNLESS OTHERWISE NOTED, RAISED STEEL BOX COVERS MAY BE USED IN UTILITY AREAS.	26.24	IDENTIFICATION: PROVIDE ENGRAVED NAMEPLATES FOR ALL SWITCHBOARDS, PANELS, TRANSFORMERS, DISCONNECTS, MOTOR STARTERS, CONTACTORS, TIME SWITCHES AND CABINETS. NAMEPLATES SHALL INCLUDE THE FOLLOWING INFORMATION AS APPLICABLE:				
26.12 26.13	TAMPER-PROOF: ALL EQUIPMENT AND CIRCUITING ACCESSIBLE BY THE PUBLIC SHALL BE TAMPER-PROOF AND VANDAL RESISTANT. OPENABLE DEVICES AND EQUIPMENT SHALL BE PADLOCKABLE. DISTRIBUTION EQUIPMENT: DISTRIBUTION EQUIPMENT SHALL BE DEAD-FRONT, PANELBOARD OR		DESIGNATION (i.e. PANEL A) FUNCTION (i.e. AIR HANDLER AH—1) VOLTAGE, PHASE, WIRE (i.e. 480 VOLT, 3ø, 4W.) FEEDER SIZE (i.e. 4—#4/0 THWN CU IN 2"C.) SOURCE (i.e. SWITCHBOARD MSB)				
	SWITCHBOARD TYPE AS INDICATED, UL—LABELED AND ENCLOSED IN A NEMA HOUSING APPROPRIATE TO ITS LOCATION AND APPLICATION WITH HINGED WIREWAY COVERS. BUSSING, DEVICE FINGERS AND LUGS SHALL BE COPPER UNLESS INDICATED ON DRAWINGS. AIC RATINGS SHOWN ON PLANS ARE MINIMUM RATINGS, CIRCUIT BREAKERS SHALL BE IN EXCESS OF THE AVAILABLE FAULT CURRENT. SERIES—RATING		NAMEPLATES SHALL BE WHITE LETTERS ON BLACK FOR NORMAL EQUIPMENT AND WHITE LETTERS ON RED FOR EMERGENCY EQUIPMENT.				
26.14	OF UPSTREAM AND DOWNSTREAM CIRCUIT BREAKERS TO ACHIEVE REQUIRED FAULT CURRENT RATINGS IS PROHIBITED UNLESS APPROVED BY ENGINEER IN WRITING. PANELBOARDS: PANELS SHALL HAVE FLUSH MONO—FLAT TRIM, LOCKING DOOR—IN—DOOR HINGED COVERS	26.25	GUARANTEE: THE COMPLETE ELECTRICAL SYSTEM, AND ALL PORTIONS THEREOF, SHALL BE GUARANTEED TO BE FREE FROM DEFECTS IN WORKMANSHIP AND MATERIALS FOR A PERIOD OF ONE YEAR FROM DATE OF FINAL ACCEPTANCE. PROMPTLY REMEDY SUCH DEFECTS AND ANY SUBSEQUENT DAMAGE CAUSED BY THE DEFECTS OR REPAIR THEREOF AT NO EXPENSE TO THE OWNER. LAMPS ARE EXEMPT FROM THIS				
	AND BOLT-ON CIRCUIT BREAKERS. FLUSH-MOUNTED PANELS SHALL HAVE EMPTY CONDUITS STUBBED TO ACCESSIBLE ATTIC SPACE: ONE 1" CONDUIT FOR EACH FOUR SPARE/SPACE CIRCUITS. PROVIDE ONE TYPED AND ONE SPARE PANEL SCHEDULE FOR OWNER'S USE. SCHEDULES SHALL BE TWO COLUMN TYPE WITH ODD CIRCUIT NUMBERS ON THE LEFT AND EVEN NUMBERS ON THE RIGHT.	26.26	GUARANTEE, BUT SHALL BE NEW AT TIME OF FINAL ACCEPTANCE. <u>SUSPENDED CEILING SYSTEMS</u> : ALL LAY—IN FIXTURES SHALL BE INDEPENDENTLY SUPPORTED BY TWO #12 SLACK WIRES ATTACHED TO TWO OPPOSITE CORNERS OF THE FIXTURE PER UBC & NEC REQUIREMENTS. THESE WIRES SHALL BE SECURED TO THE STRUCTURAL FRAMING SUCH THAT FAILURE OF THE SUSPENDED				
26.15	TRANSFORMERS: TRANSFORMERS SHALL BE SELF VENTILATED DRY—TYPE UNLESS INDICATED OTHERWISE AND SHALL BE UL LISTED AS SUITABLE FOR INSTALLATION IN INTERIOR LOCATIONS. INSULATION SHALL BE MINIMUM 220 DEGREE CELSIUS OPERATION — TEMPERATURE RISE SHALL BE MINIMUM 115 DEGREES CELSIUS. PROVIDE SIX 2 1/2% VOLTAGE ADJUSTING TAPS — TWO ABOVE AND FOUR BELOW RATED PRIMARY VOLTAGE. IMPEDANCE FOR UNITS ABOVE 15KVA SHALL BE MINIMUM 3%. WINDINGS SHALL BE COPPER UNLESS APPROVED BY ENGINEER IN WRITING. TRANSFORMERS SHALL BE CONNECTED WITH	26.27	CEILING SHALL NOT ALLOW THE FIXTURE TO DROP. COORDINATION: THE CIVIL, ARCHITECTURAL, MECHANICAL, KITCHEN AND INTERIOR DRAWINGS CONTAIN DETAIL DESCRIPTIONS, CIRCUITING AND CONNECTION REQUIREMENTS WHICH ARE PART OF DIVISION 16 RESPONSIBILITIES. ELECTRICAL CONTRACTOR SHOULD NOT SUBMIT BIDS ON THIS PROJECT BEFORE REVIEWING ALL PROJECT DRAWINGS, SPECIFICATIONS AND ADDENDA.				
26.16	SEALTIGHT FLEXIBLE CONDUIT WITH SEPARATE INTERNAL GROUND WIRE. CODE COMPLIANCE: A. WORKING CLEARANCE: THE CONTRACTOR SHALL VERIFY THAT ALL ELECTRICAL EQUIPMENT MEETS THE CLEARANCE REQUIREMENTS OF NEC 110.26. DRAWINGS REPRESENT CLEARANCES ARE MET AS DESIGNED, ANY DEVIATION SHALL ALSO MEET THIS REQUIREMENT. ELECTRICAL SWITCHBOARDS RATED 1200 AMPS OR GREATER, IN EXCESS OF 6 FEET IN LENGTH, SHALL REQUIRE TWO (2) EXITS FROM THE ELECTRICAL ROOM UNLESS NEC 110.26(C)(2)(a) OR 110.26(C)(2)(6) ARE MET. B. TRANSFORMERS: TRANSFORMERS RATED GREATER THAN 112.5 KVA SHALL BE PLACED IN ELECTRICAL ROOMS WITH A 1-HOUR FIRE RATING PER NEC 450.21(B) WHERE THEY DO NOT MEET THE TRANSFORMER SECTION. TRANSFORMERS AS SPECIFIED IN THIS SECTION MEET NEC 450.21(B) EXCEPTION #2 AND ARE NOT	26.28	FIRE ALARM: PROVIDE NEW FIRE EXTINGUISHING SYSTEM MONITOR WITH CLASS 1 CIRCUITING AS REQUIRED BY LOCAL FIRE MARSHAL AND IN COMPLIANCE WITH ADA REQUIREMENTS. CONTROL PANEL SHALL INCLUDE INTEGRAL STANDBY BATTERIES, CHARGER AND MUNICIPAL TIE MODULE OR AGENCY— APPROVED AUTO—DIALER CONNECTED TO THE TELEPHONE SYSTEM (CONNECTION AND MONITORING CHARGES BY OTHERS). PLANS DO NOT INDICATE ALL DEVICES, CONNECTIONS OR CIRCUITING REQUIRED FOR A COMPLETE SYSTEM. SUBMIT PROPOSED DESIGN TO THE FIRE MARSHAL AND RECEIVE APPROVAL PRIOR TO ROUGH—IN.				

TRANSFORMERS AS SPECIFIED IN THIS SECTION MEET NEC 450.21(B) EXCEPTION #2 AND ARE NOT REQUIRED TO BE PLACED IN A 1-HOUR RATED ROOM.

	SIGNAL OUTLETS		RECEPTACLES		ABBREVIATIONS
_	TELEPHONE: 4S BOX WITH SINGLE GANG MUD RING UON,	$\Rightarrow \Rightarrow$	DUPLEX: 20A, 125V, NEMA 5-20, +18" AFF	Q	CENTERLINE
*	+18" AFF UON	$\begin{array}{c} & & & \\ & & \\ & & & \\ & \\ & & \\ & \\ & & \\ & \\ & \\ & & \\ & \\ & & \\ & \\ & \\ & \\ & \\ & \\ & \\ & \\ & \\ & \\ & \\ & \\ &$	DOUBLE DUPLEX: 20A, 125V, NEMA 5-20, +18" AFF	AFF	ABOVE FINISHED FLOOR
▼	TELEPHONE: 4S BOX WITH SINGLE GANG MUD RING UON, WALL MOUNT +54" AFF UON	→ →	HALF SWITCHED DUPLEX: 20A, 125V, NEMA 5-20, +18" AFF	AIC	AMPERES INTERRUPTING CAPACITY
$\overline{\nabla}$	DATA: 4S BOX WITH SINGLE GANG MUD RING UON,	^	(TOP HALF SWITCHED)	AFC	ABOVE FINISH CEILING
	+18" AFF UON VOICE /DATA: AS BOY WITH SINGLE CANC MUD RING HON	**	DUPLEX GFCI: 20A, 125V, GFCI, NEMA 5-20 GFR, +18" AFF DUPLEX I.G.: 20A, 125V, ISO. GND., NEMA 5-20 IG	BMS	BUILDING MANAGEMENT SYSTEM
$lackbox{lackbox{$ abla}}$	VOICE/DATA: 4S BOX WITH SINGLE GANG MUD RING UON, +18" AFF UON	_ • ••	+18" AFF (WHITE WITH ORANGE TRIANGLE, UON)	С	CONDUIT
₹V	TELEVISION: 4S BOX WITH SINGLE GANG MUD RING UON, +18" AFF UON	⇒	DOUBLE DUPLEX I.G.: 20A, 125V, ISO. GND., NEMA 5-20 IG +18" AFF (WHITE WITH ORANGE TRIANGLE, UON)	CB	CIRCUIT BREAKER
	CAMERA: 4S BOX WITH SINGLE GANG MUD RING UON,	\Rightarrow \rightarrow	SPECIAL RECEPTACLE - AS INDICATED ON PLANS, +18" AFF	CLG	CEILING
<u>(</u>)	CEILING MOUNTED UON	NO	TE: DIAMOND SYMBOLS INDICATES DEDICATED CIRCUIT.	CIR	CIRCUIT
M	MICROPHONE: 4S BOX WITH SINGLE GANG MUD RING UON, +18" AFF UON	[7]-7-7-1	EQUIPMENT	DPDT	DOUBLE POLE DOUBLE THROW
(v)	VOLUME CONTROL: 4S BOX WITH SINGLE GANG MUD RING		SWITCHBOARD SUBFACE MOUNTED	DPST	DOUBLE POLE SINGLE THROW
· ·	UON, +48" TO TOP UON	- 	PANELBOARD: SURFACE MOUNTED	(E)	EXISTING TO REMAIN
S	SPEAKER: 8" COAXIAL WITH BACK BOX AND GRILLE, CEILING MOUNTED UON	T	PANELBOARD: FLUSH MOUNTED TRANSFORMER	ELEV	ELEVATOR
	3/4"C (UON) STUB INTO ACCESSIBLE		RELAY (120V COIL , STEP DN XFMR IF REQUIRED, UON)	EMT	ELECTRICAL METALLIC TUBING
_	CEILING SPACE SWITCHES		CONTACTOR (120V COIL, STEP DN XFMR IF REQUIRED, UON)	EPO FBO	EMERGENCY POWER OFF SYSTEM
S	SINGLE POLE: 20A, 120/277V, +48" TO TOP UON		COMBINATION MAGNETIC STARTER/FUSED DISCONNECT	FPEN FBO	FURNISHED BY OTHERS FUSE PER EQUIPMENT NAMEPLATE
S S ₂	TWO POLE: 20A, 120/277V, +48" TO TOP UON		NON-FUSIBLE DISCONNECT SWITCH	FLUOR	FLUORESCENT
S_3	THREE WAY: 20A, 120/277V, +48" TO TOP UON		FUSIBLE DISCONNECT SWITCH	FLUUR FU	FLOURESCENT FUSE: DUAL-ELEMENT, TIME DELAY
S ₄	FOUR WAY: 20A, 120/277V, +48" TO TOP UON		PULLBOX: SIZE AS REQUIRED BY NEC	GFI/GFCI	GROUND FAULT INTERRUPTER
S _x	X INDICATES EMERGENCY CIRCUIT	<i>Ø</i>	JUNCTION BOX: SIZE AS REQUIRED BY NEC	GND	GROUND
Sp	P INDICATES PILOT LIGHT (LIGHTED WHEN ON)		SURFACE RACEWAY WITH OR WITHOUT DEVICES	HOA	HAND-OFF-AUTOMATIC
S _L	L INDICATES PILOT LOCATOR (LIGHTED WHEN OFF)	TP	TELEPOWER POLE	HID	HIGH INTENSITY DISCHARGE
S _K	K INDICATES KEY OPERATED SWITCH		CIRCUITING	IG	ISOLATED GROUND
S _M	MANUAL MOTOR STARTER: 20A, 120/277V, POLES		CONDUIT IN WALL OR ABOVE CEILING	INCAND	INCANDESCENT
	AND HEATERS AS REQUIRED		CONDUIT IN FLOOR OR BELOW GRADE	K	kcmil (300K = 300 kcmil)
S _{MC}	MOMENTARY CONTACT: 20A, 120/277V, SPDT CENTER NORMALLY OFF UON, +48" TO TOP UON	***************************************	METAL CLAD CABLE (MC)	LTG	LIGHTING
D	DIMMER: 600 WATT UON, ELECTRONIC SLIDER, WITH ON/OFF TOGGLE, +48" TO TOP UON (PLANS SHALL	—ОН—	OVERHEAD SERVICE	LV	LOW VOLTAGE
	INDICATE TYPE: FLUOR, INCAND OR LOW-VOLTAGE)	— P —	PRIMARY	MCP	MOTOR CIRCUIT PROTECTOR
<u> </u>	MOTION/OCCUPANCY SENSOR SWITCH WITH OFF-AUTO SELECTOR - WALL MOUNTED AT +48" TO TOP UON	— s —	SECONDARY	МС	MULTI-CONDUCTOR CABLE
0S) = 360		<u> т — </u>	TELEPHONE	(N)	NEW
OS = 180	CEILING MOUNTED ARROWS INDICATE DIRECTION AND COVERAGE	— <i>TV</i> —	TELEVISION	NC	NORMALLY CLOSED
OS = 90	PROVIDE WITH POWER PACK PER MANUFACTURERS REQUIREMENTS		LOW VOLTAGE AND/OR CONTROL CIRCUITNG	NEUT	NEUTRAL
PE	PHOTO ELECTRIC SWITCH: 1600VA UON	—**—	EMERGENCY CIRCUIT	NL	NIGHT LIGHT
	METHODS SHADING INDICATES: FIXTURE QUITLET EQUIDMENT		STUB OUT: MARK AND CAP (SITE)	NO	NORMALLY OPEN
Z,S _X ,⊕,	SHADING INDICATES: FIXTURE, OUTLET, EQUIPMENT, ETC. ON EMERGENCY 'X' OR NIGHT LIGHT 'NL' CIRCUIT	<u></u>	CIRCUITING UP OR DOWN	NTS	NOT TO SCALE
	DEVICE MOUNTED IN MULTIPLE UNDER COMMON COVER		TICS = NO. OF #12 WIRES (UON) IF MORE THAN TWO WITHIN CONDUIT OR MC	PNL	PANEL
ss¶	MAXIMUM HEIGHT ON WALL SHALL BE +48" TO TOP UON		ISOLATED GROUNDING CONDUCTOR	PVC	POLYVINYL CHLORIDE CONDUIT
$\mathbb{Q}_{\mathbf{Z}}$	DEVICES MOUNTED IN OR ABOVE COUNTER/BACKSPLASH: MAXIMUM HEIGHT ON WALLS SHALL BE +48" TO TOP UON			(R)	EXISTING TO BE RELOCATED
	FLUSH FLOOR MOUNTED WIRING DEVICES		——————————————————————————————————————	RAC	RIGID ALUMINUM CONDUIT
	FLUSH FLOOR MOUNTED WIRING DEVICES IN SINGLE MULTI-		HOMERUN DESIGNATION	RSC	RIGID STEEL CONDUIT
	COMPARTMENT BOX		PHASE CONDUCTOR(S) GROUNDING CONDUCTOR	SLD	SINGLE LINE DIAGRAM SEAL OFF
⊕ ♦ ♦ •	RECEPTACLE MOUNTED IN CEILING OR CASEWORK	PNL-[H,H,H	Ĩ,N]G,IG → ISOLATED GROUNDING CONDUCTOR	SO SPDT	SEAL OFF SINGLE POLE DOUBLE THROW
	FINE DASHING INDICATES EXISTING EQUIPMENT AND DEVICES TO BE REMOVED		NEUTRAL CONDUCTOR (ONE PER PHASE CONDUCTOR). PANEL DESIGNATION	SPD 1 SPEN	SINGLE POLE DOUBLE THROW SIZE PER EQUIPMENT NAMEPLATE
	DESIGNATIONS		MISCELLANEOUS	SPEN SPST	SINGLE POLE SINGLE THROW
F1	LIGHT FIXTURE: F1 = TYPE (SEE FIXTURE SCHEDULE)	T	THERMOSTAT: AT +48" TO TOP UON (OR PER MECH PLANS)	TEL	TELECOM
	L.S.T. T.M. GALL TIMIONE SOMEDOLL)	(f)	EXHAUST FAN: FRACTIONAL HORSEPOWER	TYP	TYPICAL
2	SHEET NOTE	1)	MOTOR: NUMBER = HORSEPOWER	UNSW	UNSWITCHED
1	REVISION DELTA: NUMBER REPRESENTS REVISION	SIGN	SIGNAGE CONNECTION	UON	UNLESS OTHERWISE NOTED
		₹	SHUNT TRIP STATION: +7'-6" AFF, 12" RED TRIANGLE, UON	WP	WEATHERPROOF (NEMA 3R)
/ ^^ \	MECHANICAL AND PLUMBING EQUIPMENT	⊙ -I	CONTROL STATION: AT +48" TO TOP UON	WT	WA TER TIGHT
AC 1					
\longleftarrow	MISCELLANEOUS: THESE AND OTHER SYMBOLS AS INDICATED IN TABLES AND SCHEDULES ON THE PLANS.	a b	DUAL LEVEL LIGHTING CONTROL SWITCH 'a' = CENTER (1) LAMP SWITCH 'b' = OUTER (2) LAMPS	(X)	EXISTING TO BE REMOVED



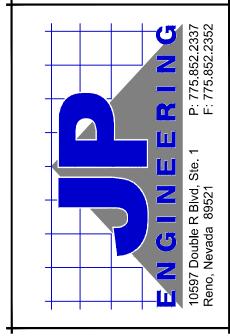



CONVERSION

REVISIONS

SHEET TITLE ELECTRICAL SYMBOLS AND SPECIFICATIONS

DRAWN:	MP
CHECKED:	JS
DATE:	27 JUNE 2023
JOB NUMBER:	JP#22206
CITY APPROVAL:	

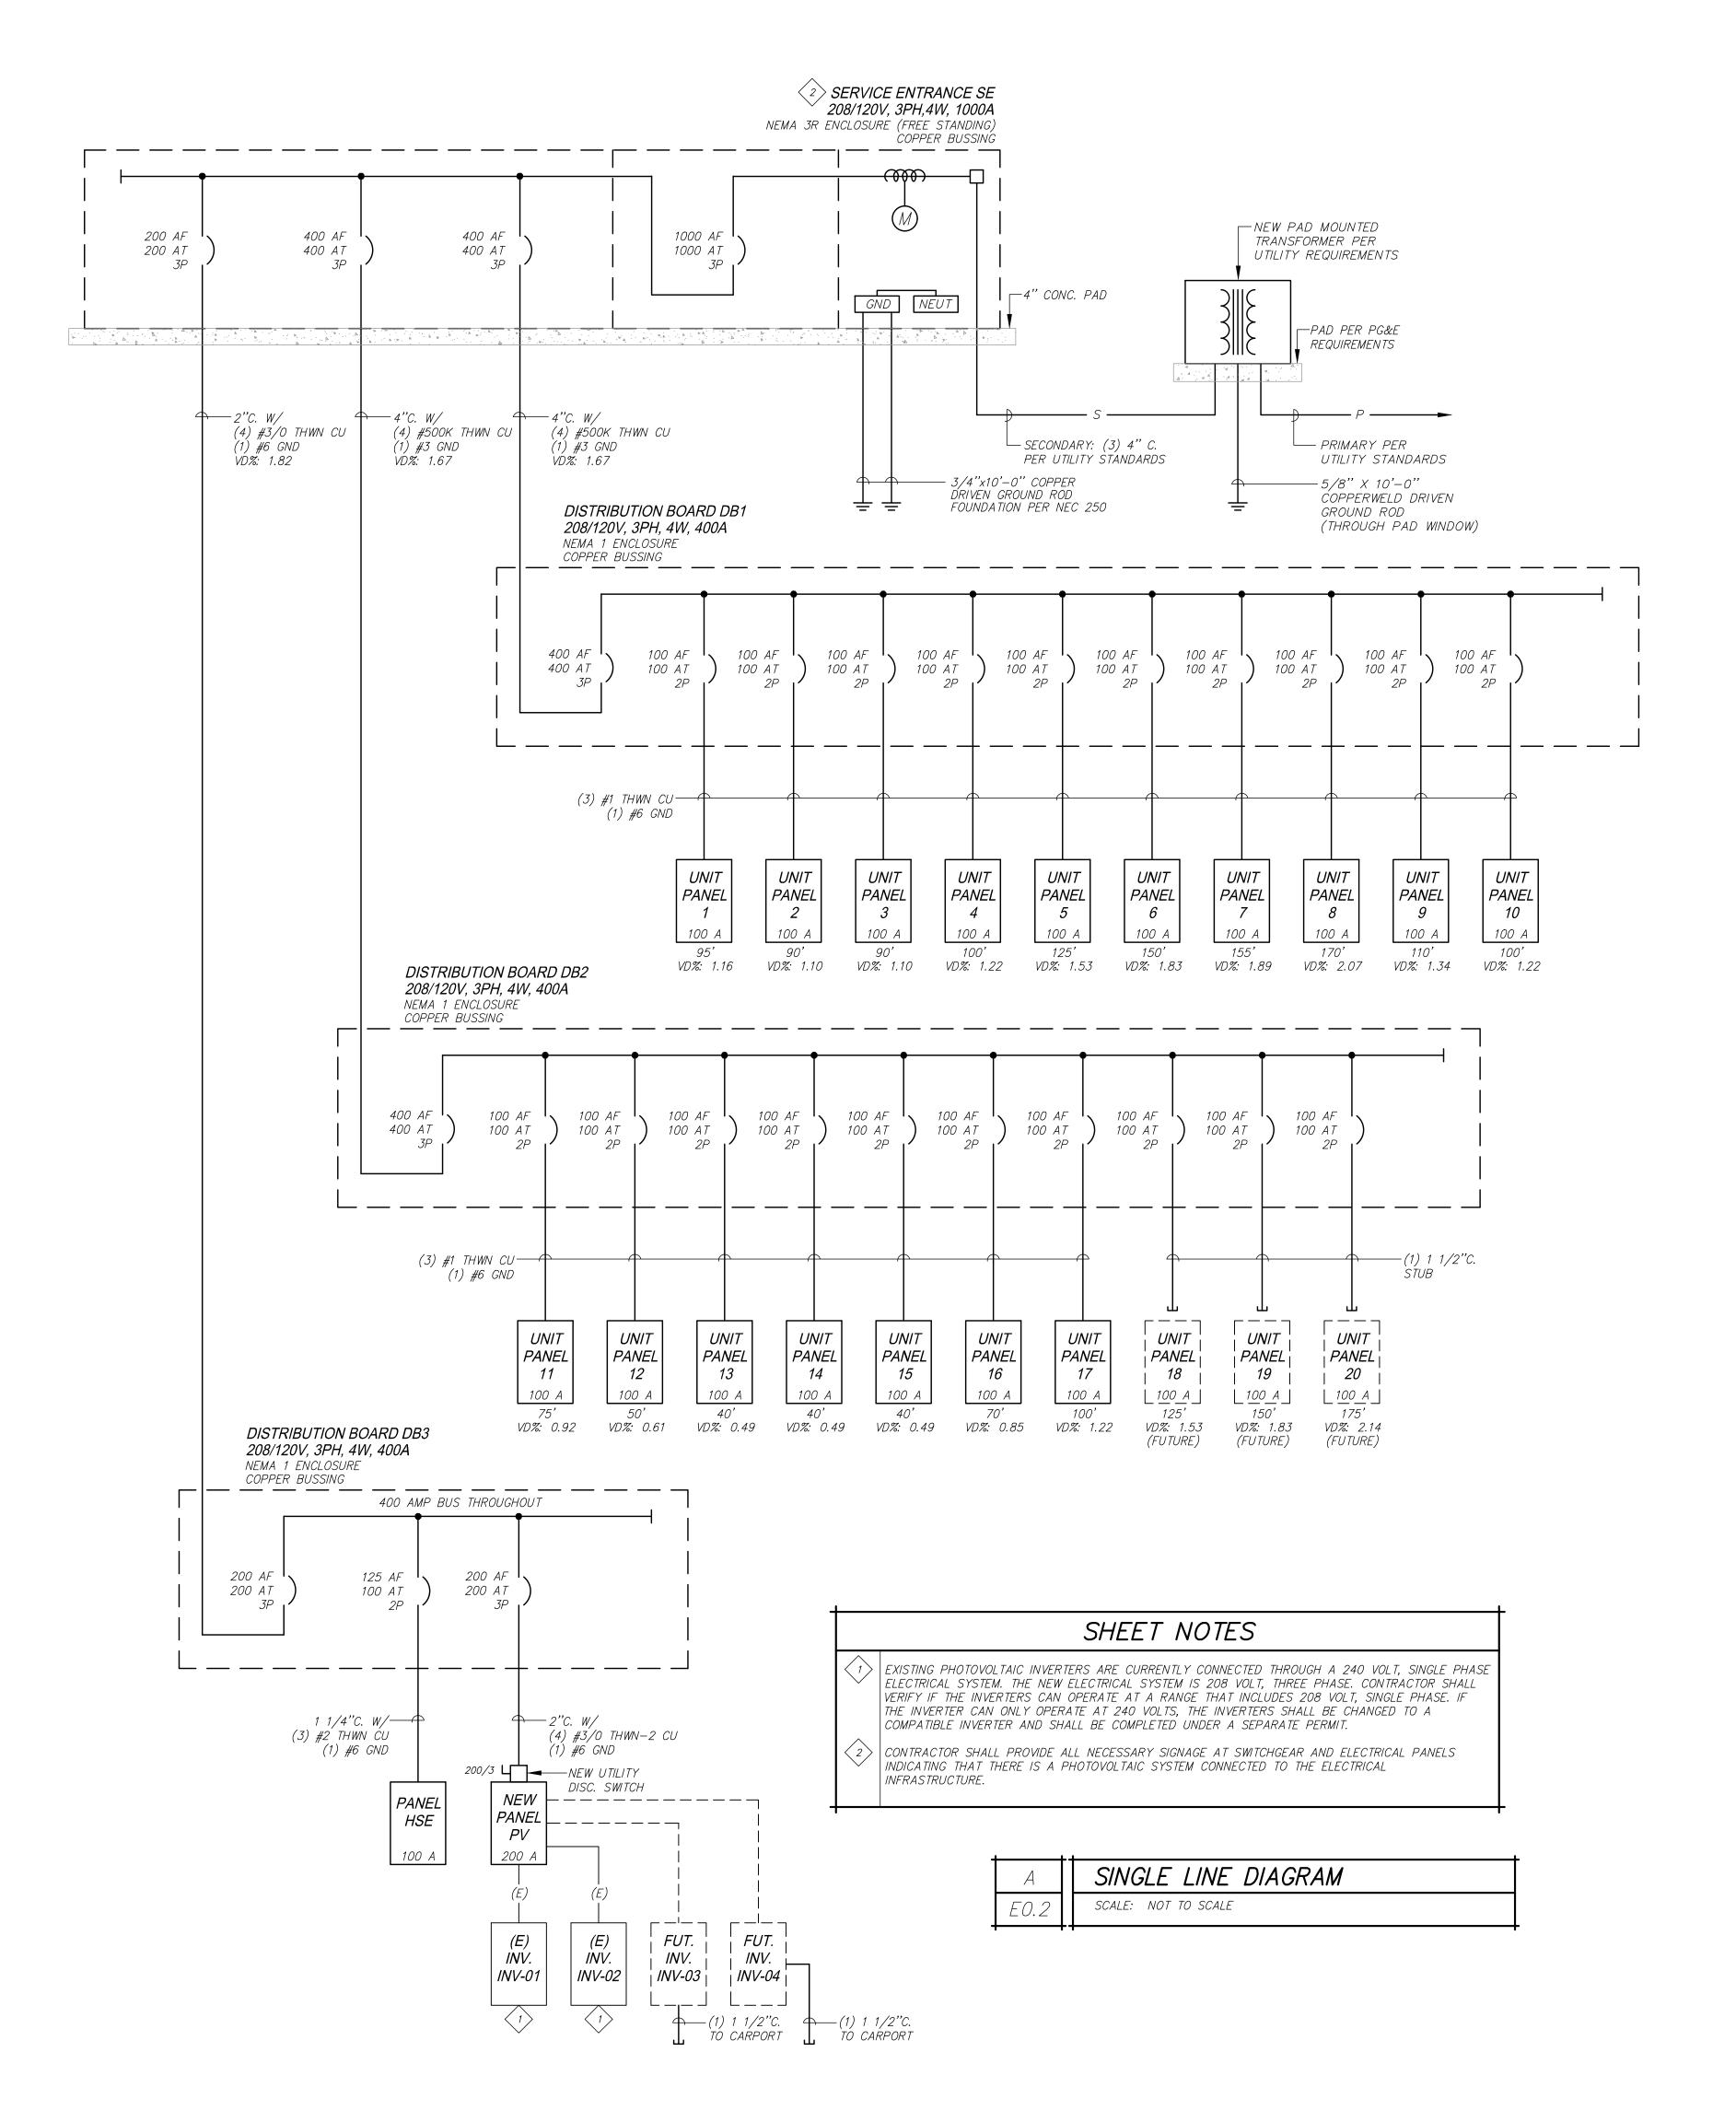

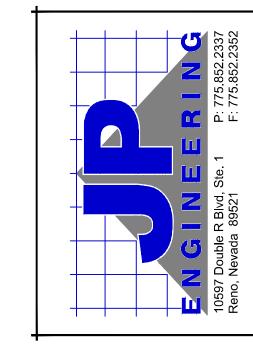



6/27/23

JOWS INN CONVE

REVISIONS

SHEET TITLE

ELECTRICAL
SCHEDULES AND
SINGLE LINE DIAGRAM

DRAWN: MP

CHECKED: JS


DATE: 27 JUNE 2023

JOB NUMBER: JP#22206

CITY APPROVAL:

E0.2



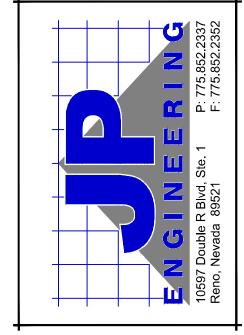



6/27/23


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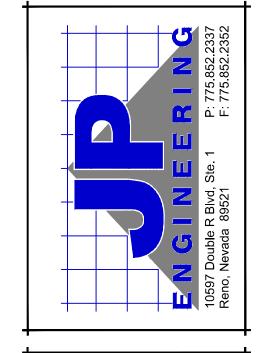
REVISIONS


SHEET TITLE
PANEL SCHEDULES

DRAWN:	MP
CHECKED:	JS
DATE:	27 JUNE 2023
JOB NUMBER:	JP#22206
CITY APPROVAL:	

E0.3



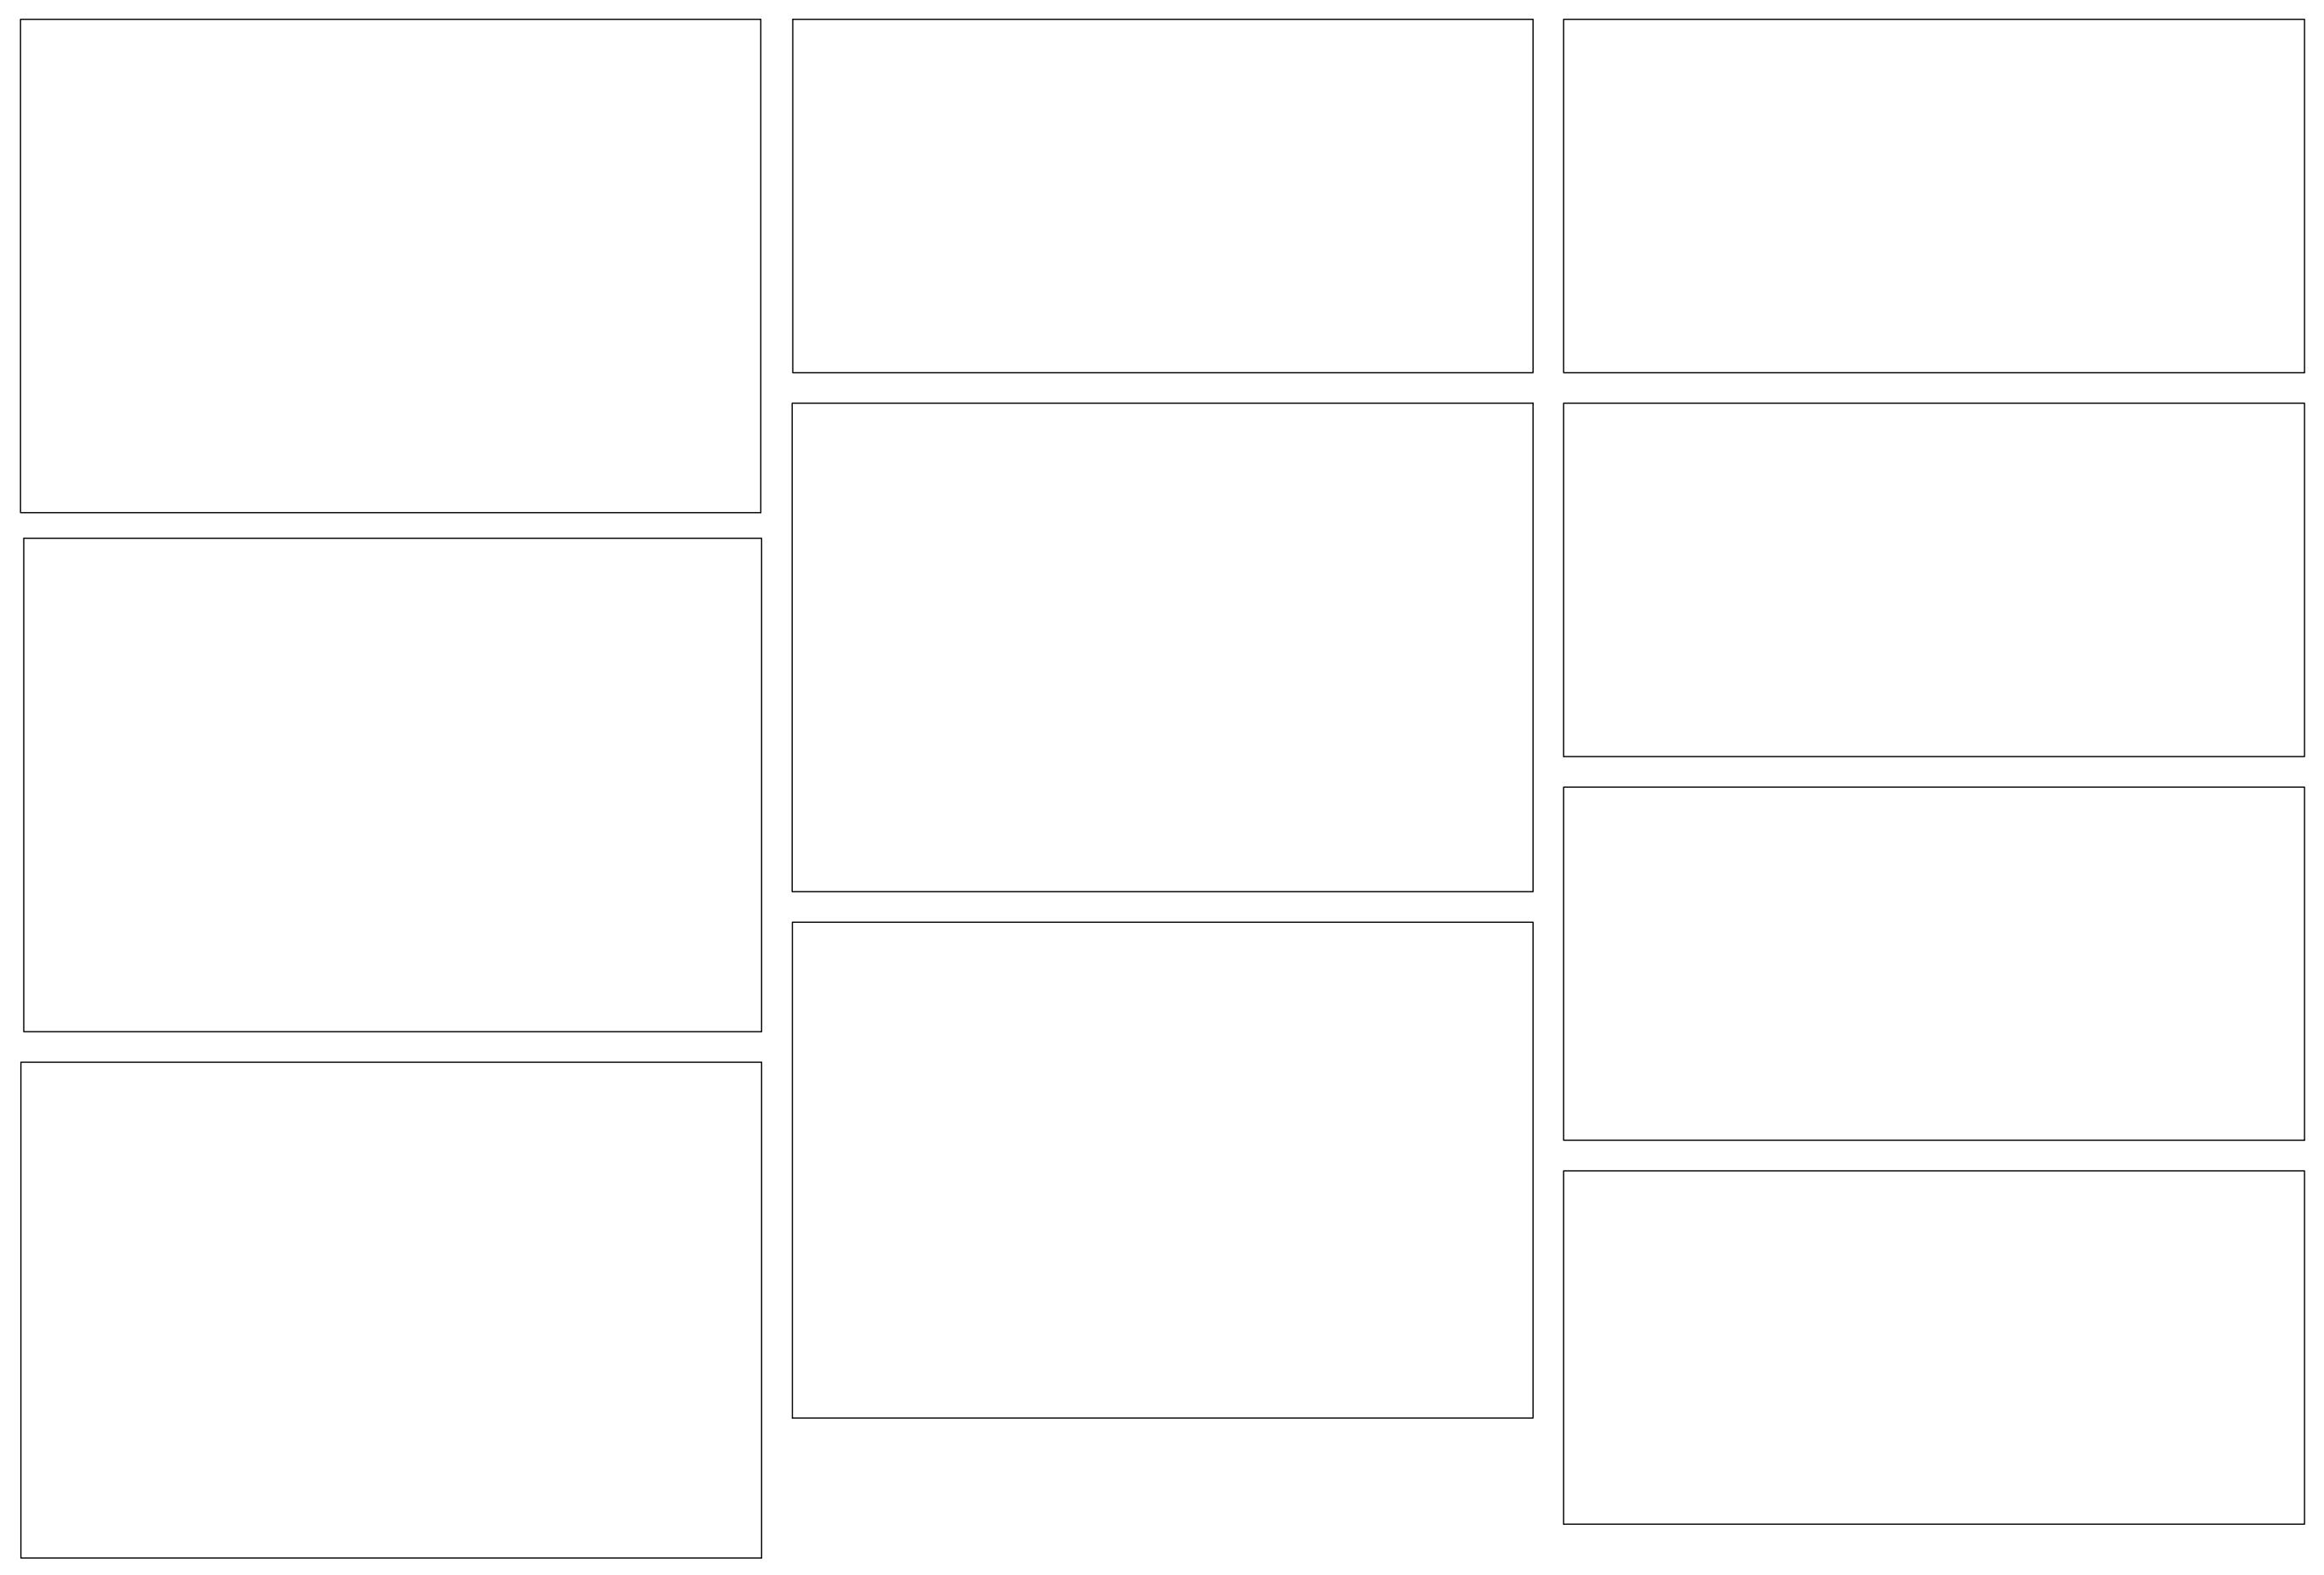

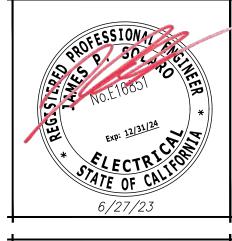

6/27/23

WILLOWS INN CONVERSION

REVISIONS

SHEET TITLE
PANEL SCHEDULES

DRAWN:	MP
CHECKED:	JS
DATE:	27 JUNE 2023
JOB NUMBER:	JP#22206
CITY APPROVAL:	


E0.4

GLENN-COLUSA CANAL

SITE ELECTRICAL PLAN

SCALE: 1/16'' = 1'-0''



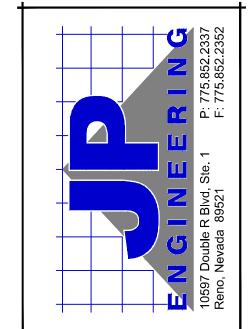



* SPECTRICAN * SPATE OF CALIFORNIA 6/27/23


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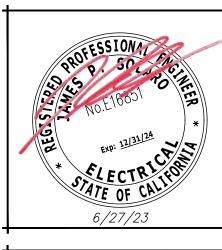
REVISIONS

SHEET TITLE
SITE ELECTRICAL PLAN

DRAWN:	MP
CHECKED:	JS
DATE:	27 JUNE 2023
JOB NUMBER:	JP#22206
CITY APPROVAL:	

E1.1



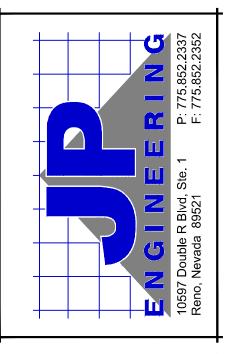


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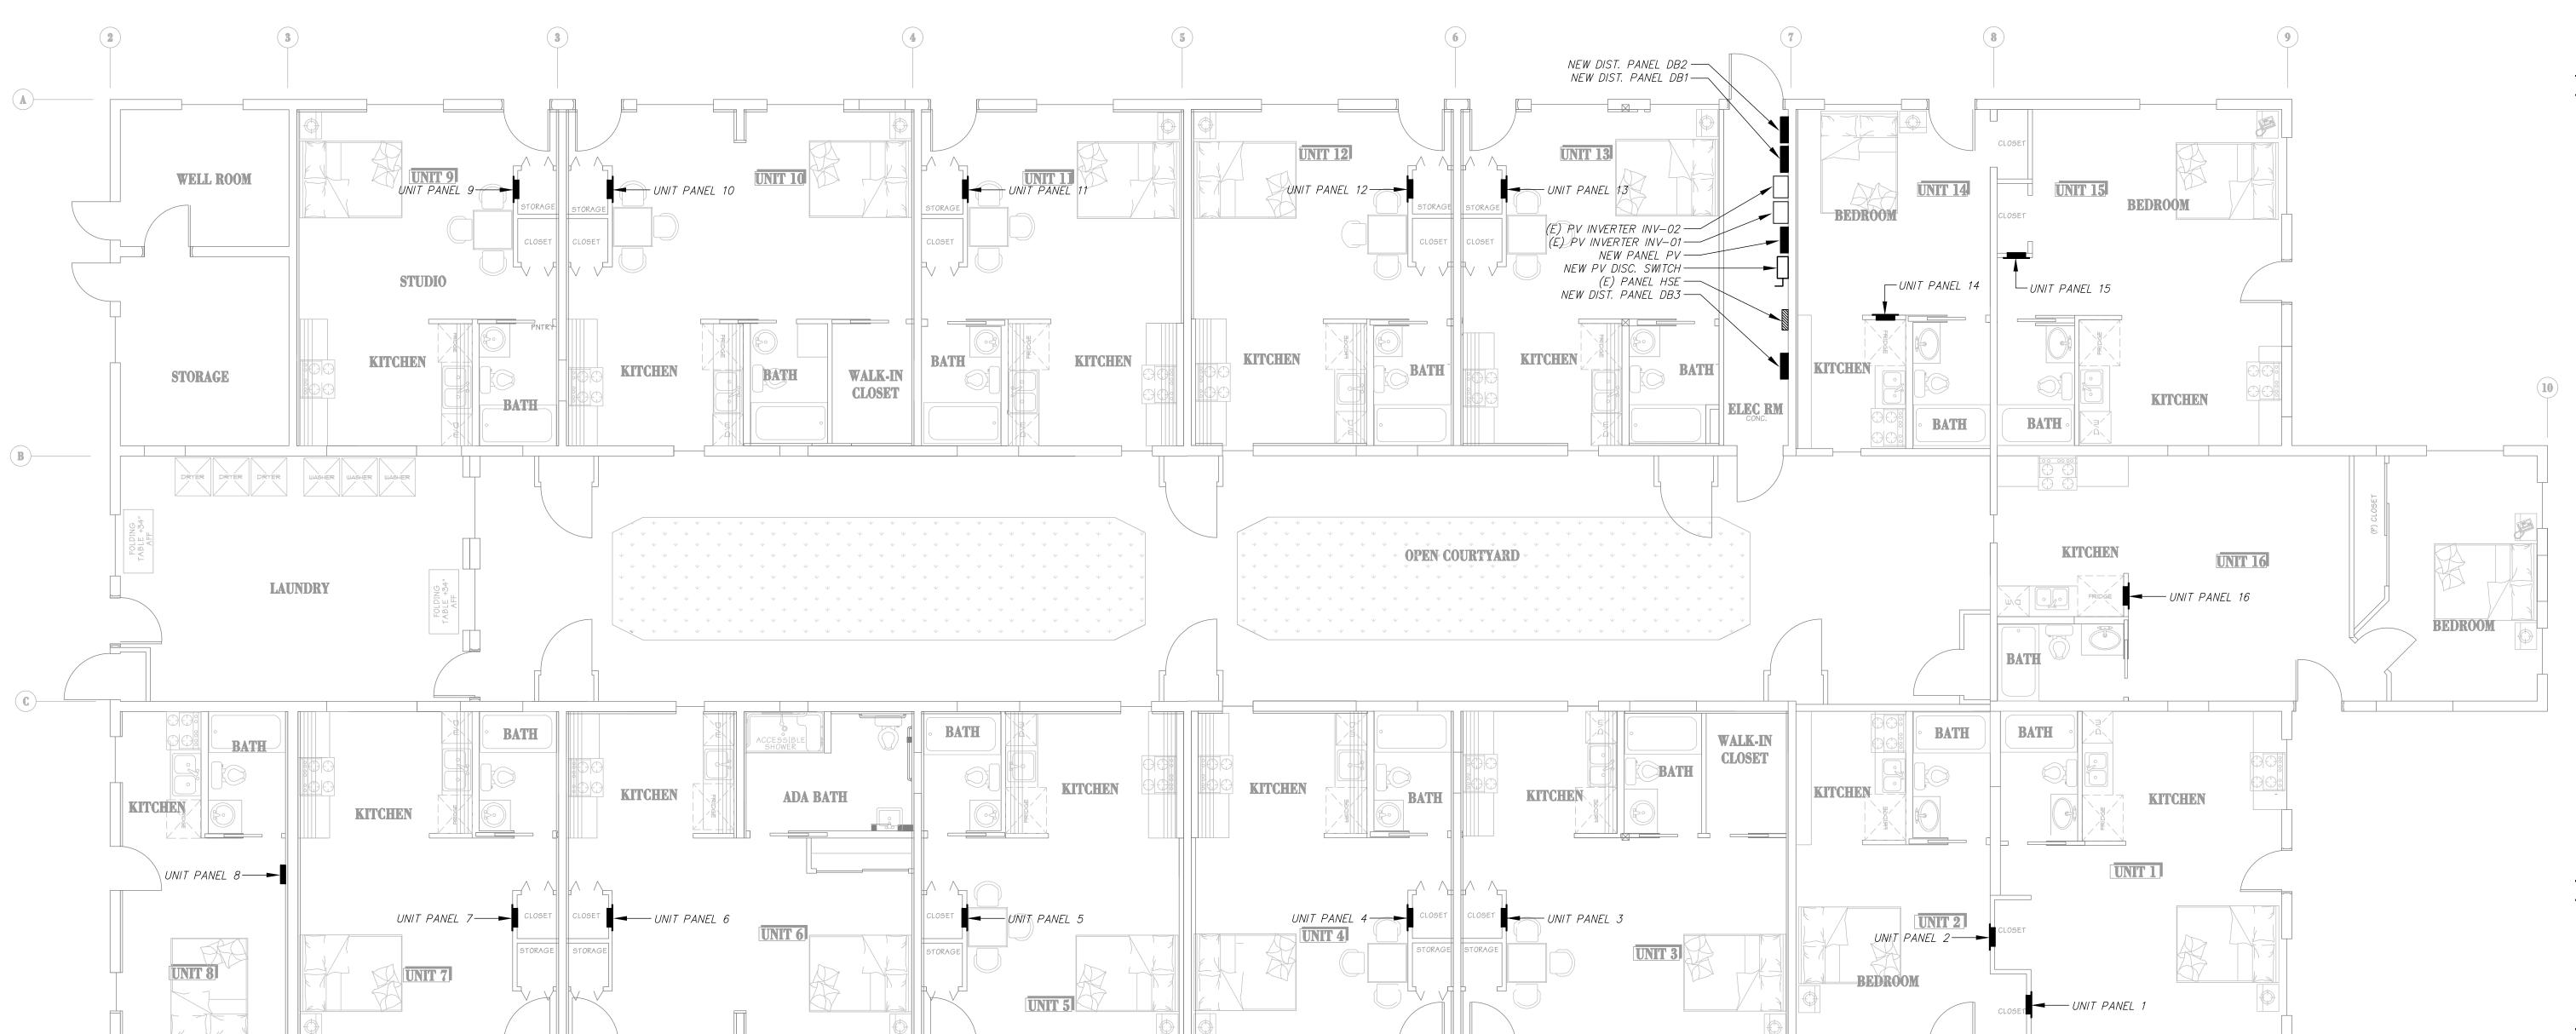
REVISIONS

SHEET TITLE OVERALL ELECTRICAL PLAN


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	DRAWN:	MP
	CHECKED:	JS
	DATE:	27 JUNE 2023
	JOB NUMBER:	JP#22206
	CITY APPROVAL:	

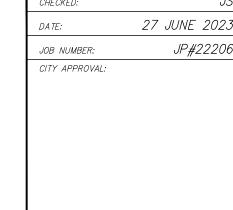

E2.1



E2.1 SCALE: 3/16" = 1'-0"	A	OVERALL ELECTRICAL PLAN	
	E2.1	SCALE: 3/16" = 1'-0"	

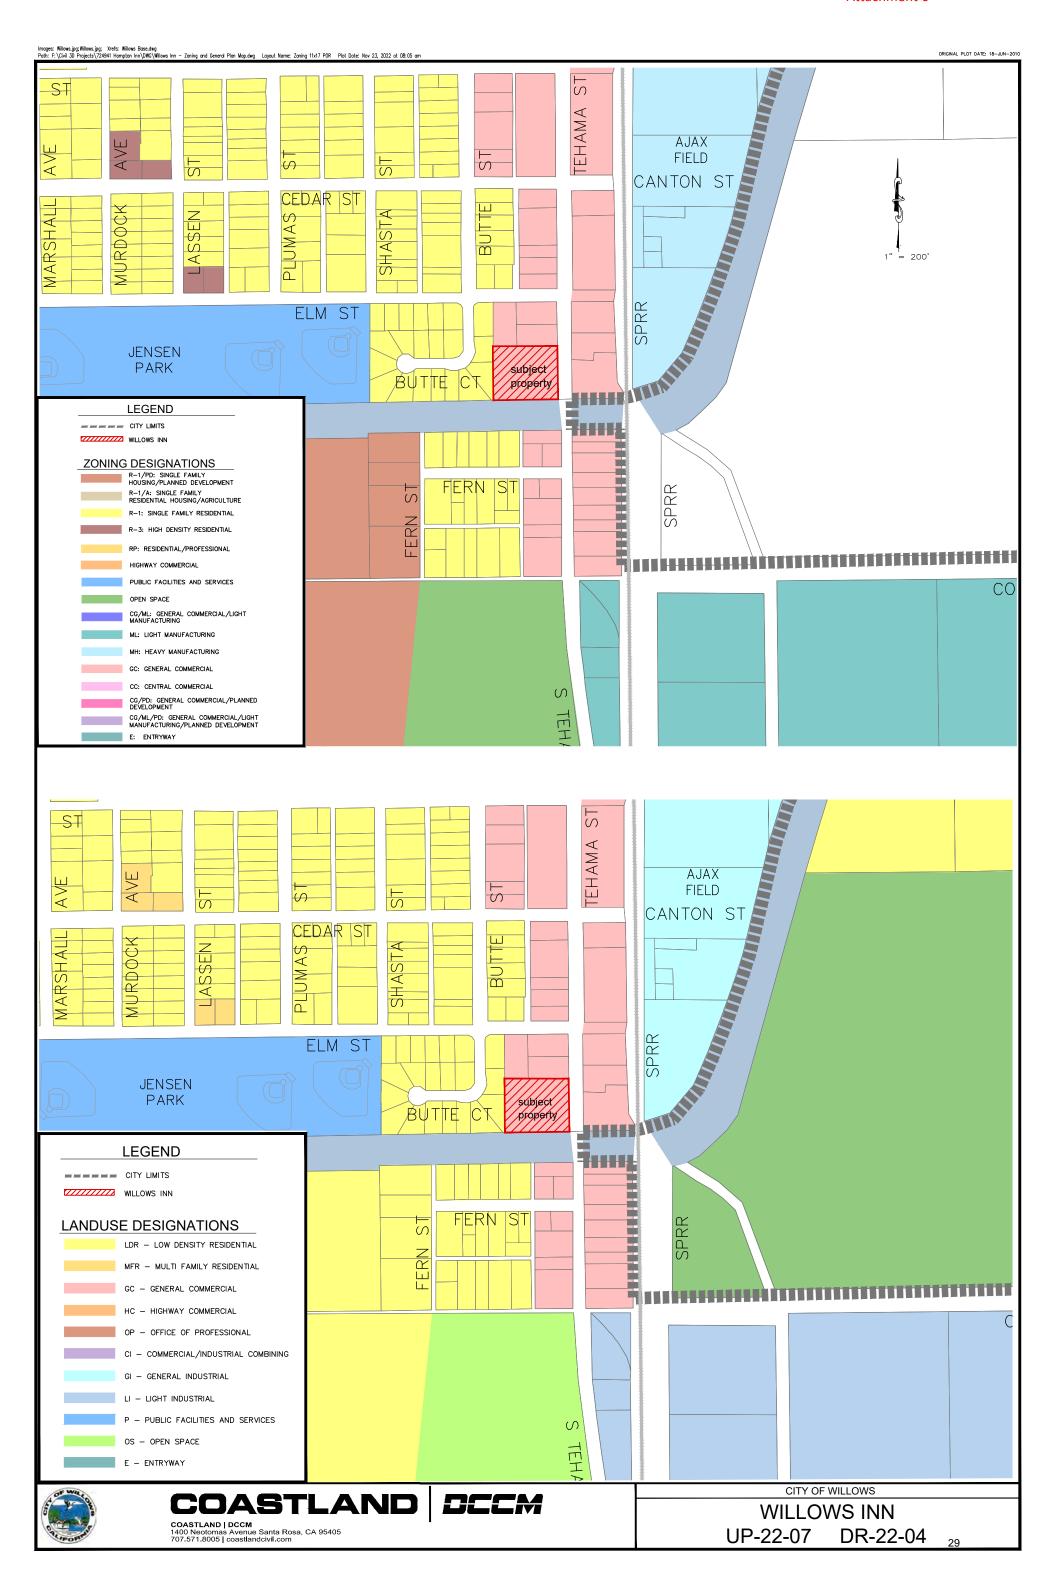



DISCUSSION & ACTION CALENDAR



Date: July 19, 2023

To: Planning Commission/Architectural Design Review Board

From: Karen Mantele, Principal Planner

Subject: One year extension of Design Review approval File#DR-21-02

Recommendation:

Staff recommends receive the Staff Report, attachments, discuss, and upon conclusion, by voice vote determine approving the request.

Rationale for Recommendation:

WMC Section 19.141.100 (2) allows for a one-year extension of a Design Review approval.

Background:

On July 21, 2021, the Planning Commission approved the Jack in the Box proposed fast food facility. This approval included a Design Review approval for the facility. Per WMC 18.141.100 the city may grant an extension of not more than one year from the original date of expiration, if there have not been substantial changes in the factual circumstances surrounding the originally approved design or use. Therefore, administrative approval was granted to Jack in the Box in August of 2022 for a one-year extension. The code goes on to state that beyond that one-year approval, any further extension beyond one year shall require planning commission approval.

The request at this time as shown in the attached letter is for a one-year extension to this Design Review. The Use Permit extension can be an administrative one, handled by the City Manager.

Fiscal Impact:

There is no cost to the city associated with this request as the project has a PTA deposit on file.

Attachment:

1. Applicant letter requesting extension to Design Review approval



PM Design Group, Inc

6930 Destiny Dr., Ste. 100 Rocklin, CA 95677 P: 916.415.5358 F: 916.303.4330

July 11, 2023

City of Willows, Planning Department 201 North Lassen Willows, CA 95988 530-934-7041

Design Review DR-21-02 & Use Permit UP-21-03

Re: Jack in the Box 1240 W. Wood St.

Willows, CA / APN:001-041-014&-015

Dear Karen Mantele,

This letter is to request a one year extension on the existing Use Permit and Design Review approvals listed above for the proposed Jack in the Box located at 1240 W. Wood St. Due to delays in equipment availability, increased construction costs, and extended timeline for obtaining required Engineering permits...the construction schedule for this project has been changed to an estimated start date in the 4th quarter of 2023.

Sincerely,

Pedro McCracken Design Group, Inc.

Greg Borchardt
Project Manager
gborchardt@pmdginc.com
916-303-4512



COMMENTS AND REPORTS