

# Willows Planning Commission Regular Meeting Agenda

July 21, 2021 Willows City Hall 7:00 p.m.

PLANNING COMMISSION Hilgard Muller, Chair Jose Hansen, Vice Chair Candis Woods, Commissioner Robert Griffith, Commissioner Pedro Bobadilla, Commissioner

> **CITY PLANNER** Karen Mantele

MINUTE CLERK Maria Ehorn

201 North Lassen Street Willows, CA 95988 (530) 934-7041

- CALL TO ORDER 7:00 p.m.
- **PLEDGE OF ALLEGIANCE**
- 3. **ROLL CALL**
- PUBLIC COMMENT/WRITTEN COMMUNICATIONS
  - a. Public Comments:

Members of the public wishing to address the Commission on any item(s) not on the agenda may do so at this time when recognized by the Chair; however, no formal action will be taken unless a majority consensus of the Commission directs staff to place the item on a future agenda. Public is advised to limit discussion to one presentation per individual. While not required, please state your name and address for the record. (Oral communications will be limited to three minutes)

#### **CONSENT AGENDA**

Consent items are considered to be routine by the Planning Commission and will be enacted in one motion. There will be no separate discussion on these items unless a Commission Member requests, in which event the item will be removed from the consent agenda. It is recommended that the Commission:

- a. Approval of minutes of the Regular Planning Commission Meeting held on June 16, 2021.
- Approval of minutes of the Special Planning Commission Meeting held on June 30, 2021.

Comments from the public are welcome. The Chair will allow an opportunity for comments related to Public Hearings and each action item on the agenda. Please limit comments to three minutes per topic, and one comment per person per topic. Once comments conclude, please allow the Commission the opportunity to continue its consideration of the item without interruption.

- **REGULAR BUSINESS AGENDA/PUBLIC HEARING(S)**
- Staff recommends Commission receive the staff report, attachments, discuss and upon conclusion, consider the adoption of the attached resolution A RESOLUTION OF THE PLANNING COMMISSION OF THE CITY OF WILLOWS GRANTING DESIGN REVIEW APPROVAL FOR A NEW 2739 SF COMMERCIAL BUILDING AND SITE IMPROVEMENTS FILE # DR-21-02 AND USE PERMIT APPROVAL FOR 148.70 SF OF ADDITIONAL INCIDENTAL SIGNAGE FILE #UP-21-03 TO TBS Holdings LLC FOR THE PROJECT LOCATED AT 1240 W WOOD STREET ASSESSORS PARCEL NUMBERs 001-041-014 & 001-041-015.
- 7. COMMISSION/STAFF REPORTS/COMMENTS
- Commission reports/Comments.
- Staff Reports/Comments.
- **ADJOURNMENT**

This agenda was posted on July 15, 2021

Maria Ehorn, Minute Clerk

A complete agenda packet, including staff reports and back-up information, is available for public inspection during normal work hours at City Hall or the Willows Public Library at 201 North Lassen Street in Willows or on the City's website at <a href="www.cityofwillows.org">www.cityofwillows.org</a>.

In compliance with the Americans with Disabilities Act, the City of Willows will make available to members of the public any special assistance necessary to participate in this meeting. The public should contact the City Clerk's office at 934-7041 to make such a request. Notification 72 hours prior to the meeting will enable the City to make reasonable arrangements to ensure accessibility to this meeting.

The City of Willows is an Equal Opportunity Provider



# ACTION MINUTES OF THE WILLOWS PLANNING COMMISSION REGULAR MEETING HELD JUNE 16, 2021

Meeting audio is available at the City of Willows website. This is not a live feature. Audio recordings are posted the succeeding business day following the scheduled Planning Commission Meeting.

Please visit www.cityofwillows.org for free PodBean recordings.

1. Chair Muller called the meeting to order at 7:00 p.m.

2. The meeting opened with the Pledge of Allegiance led by Chair Muller.

3. Roll Call:

Commissioners Present: Muller, Hansen, Woods, Griffith

Absent: Bobadilla

Staff Present: Karen Mantele, City Planner, Maria Ehorn, Minute Clerk

4. Public Comment/ Written Communications: None

5. Consent Agenda:

a. Approval of minutes of the Regular Planning Commission Meeting held on May 19, 2021.

**Action:** 

Motion: Vice Chair Hansen / Commissioner Woods

Moved to approve the minutes of May 19, 2021, as presented.

#### The motion passed 3/0 carried by the following voice vote:

AYES: Muller, Hansen, Woods,

NOES:

ABSENT: Bobadilla ABSTAIN: Griffith

#### 6. REGULAR BUSINESS AGENDA/PUBLIC HEARING(S)

a. Staff recommends Commission receive the staff report, attachments, discuss and upon conclusion, consider the adoption of the attached resolution GRANTING DESIGN REVIEW APPROVAL (FILE# DR-20-02) TO ELEMENT 7 WILLOWS, LLC TO ALLOW CONSTRUCTION OF A NEW 2,800 SF RETAIL COMMERCIAL BUILDING AND PROJECT SITE IMPROVEMENTS FOR PROPERTY LOCATED AT 102 HARVEST DRIVE, ASSESSORS PARCEL NUMBER 017-350-005.

Casey Snow, the architect for Element 7 was in attendance and provided information on the building style.

Public hearing opened 7:13pm.

Public hearing closed 7:14pm.

#### Action:

Motion: Commissioner Griffith / Second: Commissioner Woods

Moved to approve the resolution entitled; GRANTING DESIGN REVIEW APPROVAL (FILE# DR-20-02) TO ELEMENT 7 WILLOWS, LLC TO ALLOW CONSTRUCTION OF A NEW 4,252 SF RETAIL COMMERCIAL BUILDING AND PROJECT SITE IMPROVEMENTS FOR PROPERTY LOCATED AT 102 HARVEST DRIVE, ASSESSORS PARCEL NUMBER 017-350-005.

#### The motion passed 4/0 carried by the following voice vote:

AYES: Muller, Hansen, Woods, Griffith

NOES:

ABSENT: Bobadilla

ABSTAIN:

b. Staff recommends Commission receive the staff report, attachments, discuss and upon conclusion, consider the adoption of the attached resolution GRANTING DESIGN REVIEW APPROVAL (FILE# DR-21-04) TO HPD WILLOWS-OROVILLE LP TO INSTALL NEW FAÇADE TREATMENTS TO AN EXISTING COMMERCIAL APARTMENT BUILDING (WILLOWS OAKS APARTMENTS) AND INSTALL ADA IMPROVEMENTS FOR PROPERTY LOCATED AT 1201 W WOOD STREET, ASSESSORS PARCEL NUMBER 005-370-018.

Public hearing opened 7:32. Doug Ross had a question regarding the color options. Public hearing closed 7:35

#### Action:

Motion: Vice Chair Hansen / Second: Commissioner

Moved to approve the resolution entitled; GRANTING DESIGN REVIEW APPROVAL (FILE# DR-21-04) TO HPD WILLOWS-OROVILLE LP TO INSTALL NEW FAÇADE TREATMENTS TO AN EXISTING COMMERCIAL APARTMENT BUILDING (WILLOWS OAKS APARTMENTS) AND INSTALL ADA IMPROVEMENTS FOR PROPERTY LOCATED AT 1201 W WOOD STREET, ASSESSORS PARCEL NUMBER 005-370-018 WITH THE OPTION 1 COLOR SCHEME.

#### 2. The motion passed 4/0 carried by the following voice vote:

3. AYES: Muller, Hansen, Woods, Griffith

**4.** NOES:

5. ABSENT: Bobadilla

**6.** ABSTAIN:

#### 7. COMMISSION/STAFF REPORTS/COMMENTS.

- a. Staff Reports/Comments: Karen Mantele gave brief updates/status of upcoming and ongoing projects.
- b. Commission Reports/Comments: Commissioners gave comments/reports on activities and various meetings they attended.
- 8. ADJOURNMENT:

The meeting was adjourned at 8:24 p.m.

	Hilgard Muller – Chair
Maria Ehorn – Minute Clerk	



# ACTION MINUTES OF THE WILLOWS PLANNING COMMISSION SPECIAL MEETING HELD JUNE 30, 2021

Meeting audio is available at the City of Willows website. This is not a live feature. Audio recordings are posted the succeeding business day following the scheduled Planning Commission Meeting.

Please visit www.cityofwillows.org for free PodBean recordings.

- 1. Chair Muller called the meeting to order at 3:00 p.m.
- 2. The meeting opened with the Pledge of Allegiance led by Chair Muller.
- 3. Roll Call:

Commissioners Present: Muller, Hansen, Woods, Griffith, Bobadilla

Absent

Staff Present: Karen Mantele, City Planner, Wayne Peabody, Interim City Manager, Maria Ehorn, Minute Clerk

- 4. Public Comment/ Written Communications: None
- 5. REGULAR BUSINESS AGENDA/PUBLIC HEARING(S)
  - a. Staff recommends Commission receive the staff report, attachments, discuss and upon conclusion, consider the adoption of the attached resolution A RESOLUTION OF THE PLANNING COMMISSION OF THE CITY OF WILLOWS GRANTING USE PERMIT APPROVAL (FILE # UP-21-02) ALLOWING THE ESTABLISHMENT OF A MOBILE FOOD UNIT AND DESIGN REVIEW APPROVAL OF THE CARPORT (FILE#DR-21-03) TO KALE GIESBRECHT (K&J BBQ) FOR PROPERTY LOCATED AT 244 E. CEDAR STREET, WITHIN THE CG ZONING DISTRICT ASSESSORS PARCEL NUMBER 002-302-005.

City Planner, Karen Mantele, presented the item. Kale Giesbrecht was in attendance and answered questions from the Commission.

Public hearing opened 3:15 pm.

Public hearing closed 3:15 pm.

#### Action:

Motion: Vice Chair Hansen / Second: Commissioner Woods

Moved to approve the resolution entitled; GRANTING USE PERMIT APPROVAL (FILE # UP-21-02) ALLOWING THE ESTABLISHMENT OF A MOBILE FOOD UNIT AND DESIGN REVIEW APPROVAL OF THE CARPORT (FILE#DR-21-03) TO KALE GIESBRECHT (K&J BBQ) FOR PROPERTY LOCATED AT 244 E. CEDAR STREET, WITHIN THE CG ZONING DISTRICT ASSESSORS PARCEL NUMBER 002-302-005 WITH AMENDMENTS TO THE CONDITIONS OF APPROVAL AS DISCUSSED.

#### The motion passed 5/0 carried by the following voice vote:

AYES: Muller, Hansen, Woods, Griffith, Bobadilla

NOES:

ABSENT:

#### ABSTAIN:

b. Staff recommends Commission receive the staff report, attachments, discuss and upon conclusion, consider the adoption of the attached resolution A RESOLUTION OF THE PLANNING COMMISSION OF THE CITY OF WILLOWS GRANTING MAJOR USE PERMIT APPROVAL (FILE # MUP-20-05) TO GARY EVANS ALLOWING A CHANGE OF USE FROM COMMERCIAL USE AS AN EXTENDED STAY MOTEL TO A 14 UNIT-MULTI-FAMILY RESIDENTIAL APARTMENT COMPLEX WITH NO CARPORTS FOR THE PROJECT LOCATED AT 601 N TEHAMA STREET ASSESSORS PARCEL NUMBER 005-283-015.

City Planner, Karen Mantele, presented the item. Wayne Peabody, Interim City Manager, provided information and answered questions from the commission. Gary Evans was in attendance and answered questions from the commission.

Public hearing opened 3:55 pm. Doug Ross spoke on the issue.

Public hearing closed 4:00 pm.

#### Action:

Motion: Vice Chair Hansen / Second: Commissioner Woods

Moved to approve the resolution entitled; GRANTING MAJOR USE PERMIT APPROVAL (FILE # MUP-20-05) TO GARY EVANS ALLOWING A CHANGE OF USE FROM COMMERCIAL USE AS AN EXTENDED STAY MOTEL TO A 14 UNIT-MULTI-FAMILY RESIDENTIAL APARTMENT COMPLEX WITH NO CARPORTS FOR THE PROJECT LOCATED AT 601 N TEHAMA STREET ASSESSORS PARCEL NUMBER 005-283-015 WITH AMENDMENTS AS STATED AND A REVIEW IN 6 MONTHS.

# The motion passed 5/0 carried by the following voice vote: AYES: Muller, Hansen, Woods, Griffith, Bobadilla NOES: ABSENT: ABSTAIN: 6. COMMISSION/STAFF REPORTS/COMMENTS. a. Staff Reports/Comments: Karen Mantele gave brief updates/status of upcoming and ongoing projects. b. Commission Reports/Comments: Commissioners gave comments/reports on activities and various meetings they attended. 7. ADJOURNMENT: The meeting was adjourned at 4:03 p.m. Hilgard Muller – Chair

#### **Planning Commission Agenda Report:**

July 21, 2021

Project: Design Review (File#DR-21-02) & Use Permit (File #UP-21-03)

New commercial building with site improvements and additional

incidental signage

Applicant(s)/Owner: Greg Borchardt @PM Design Group/TBS Holdings LLC

Project Location: 1240 W. Wood Street

Parcel Nos: 001-041-014 & 001-041-015
Zoning: Highway Commercial (HC)
General Plan Highway Commercial

#### **Project Description**

The applicant on behalf of the property owner, has submitted Design Review and Use Permit planning applications for review and consideration by the Commission for a new 2,739 square foot fast food restaurant commercial building, to include a double drive through. Site improvements to include ADA accessible parking stalls and path of travel, striped parking lot, new trash enclosure, and other site related improvements associated with new development. The project sits on two lots which will have to be merged. Entrance into the building is from the north and west sides of the building. The proposed hours of operation are Monday-through Sunday 6:00am to midnight for dining room area eating, and 24-hours operation for the drive through. The number of employees on largest shift is eight.

#### **Review Process**

This matter is before the Planning Commission pursuant to Willows Municipal Code Section 2.45, 18.135, and 18.65.020(3).

#### Zoning

The two parcels are located on W. Wood Street (one sits south of the front lot) with the same zoning to the south, north and east. To the west is Entryway zoning. Past uses on the parcels were auto repair/tire businesses. However, all buildings have now been demolished, including the car wash. The front parcel history was a Texaco gas station, which petroleum tanks have been removed per the applicant. The zone allows for many commercial uses, and restaurants are one of the permitted uses allowed per WMC 18.65.020(3).

#### **Design Review Analysis:**

**Competent Design**. The proposed structure has been designed by professional architects/engineers licensed within the State of California to meet the building code standards of development. The single-story building will have parapets to screen the rooftop where the mechanical equipment will be located. The height of the building with the parapet is between 20 - 23 feet high.

Relationship between Structures within the Development and between Structures and Site: The new structure will be placed along the southeastern side of the parcels (when combined) and visible from W. Wood Street. The Design Review code states that "The design shall show that due regard has been given to orientation of structures to streets, climatic considerations, and especially, the creation and utilization of open space." Placing the building along the eastern property line allows for a larger open space for parking and landscaping. There are no awnings on the western side of the building, only a cover over the entrance.

**Relationship between Development and Neighborhood**: The addition of a 2739 SF retail structure will not be out of character for the neighborhood, as commercial uses surround this property.

Materials and Colors Used: The new building will have an exterior cement plaster sand finish with the main body color of a "Quartz Grey" color and a "Mindful Gray" color, both on the softer brown/grey scheme. The bottom of the building will have an accent color of "Black Fox" a darker brown color, with another accent element used on approximately 1/3 of the building, a porcelain tile-like look which will be a "Sweet Georgia Brown" color. Another accent color used in places on the building is "Red Bay" a deeper red/brown color. The top edge of the building will have aluminum coping in the Quartz Grey color. Corrugated wall panels in the red bay color are mixed in with the areas using this accent color.

**Utility Service:** All new utilities shall be placed underground as conditioned by the Engineering Department.

**Lighting**. Lighting will be installed on the site. Exterior building wall fixtures will be installed on the building and required to be downcast. LED pole light standards will be located in the parking lot. A photometric plan shall be submitted for review to ensure that lighting will not be over glaring and/or project onto adjacent property. The code states *Light sources shall not create a glare or hazard on adjoining streets or be annoying to adjacent properties or residential areas*.

**Signage:** The sign plans submitted did not propose a pole sign, however staff was informed recently that they intend to install one. This can be part of the conditions. This project will install other new signage to advertise and sell their products. More discussion on signage under Use Permit, as the proposed amount of incidental signage exceeds the allotted amount per the sign code.

Wall, Fences or Screening: No new walls or fences around the property perimeter are proposed with this project. An enclosed trash receptacle is included on the site, located in the far southern portion of the lot area and will be screened and enclosed with a gate. All waste and recycling including cardboard will be in a secured, screened space. The trash hauler was concerned of drive through stacking causing a problem with them getting to the enclosure. However, given the layout of the site there is sufficient room for movement of their vehicles and still allowing the users access to the drive through area. A loading zone is provided for delivery of goods and equipment.

Surface Water Drainage: All surface/on-site water shall drain properly. The code states that Stormwaters shall be removed and carried away in an adequate drainage system. Surface water and all paved areas shall be collected at intervals so that it will not obstruct the flow of vehicles or pedestrian traffic and will not create puddles on the paved areas. The project is conditioned as such within the Engineering conditions.

**Landscaping:** Landscaping is proposed for the site to include trees, shrubs and ground cover, which will border the entire site. Trees have been placed in the parking areas in order to provide future shade for users.

**Drives, Parking and Circulation**: Access to the project site will be provided by one of two driveways located along Wood Street. Parking will be provided for all uses per Municipal Code Section 18.120.020. Parking requirements for Restaurants is one parking space for each 200 SF of gross floor area <u>or</u> one parking space for every four seats. Additionally, one parking space for every two employees. Using the SF calculation, the site would require 14 parking spaces plus 4 for the employees (18). Using the seat calculation, the site would require 16 parking spaces plus 4 for the employees (20). Therefore, the equation to use for this project is the seat requirement. The proposal calls for 64 indoor seats. The plan

calls for a total of 30 parking spaces, which is more than sufficient to meet the needs and code requirement.

#### **Use Permit Analysis:**

The project proposes two types of signage; an 8' high x 5.5' wide monument sign, with the company brand logo, and building and marquee signage to include both identity and incidental signage. The building frontage and the parking lot frontage equates to allowing 138 SF of identity signage (which advertises the business name). This project proposes approximately 136.48 SF of identity signage, which includes the monument sign, and the wall signs, thereby meeting the allowed amount of identity signage square footage.

The proposed incidental signage, which includes the poster marquee and menu signs (*prices and products for sale*), totals 208.70 SF, which exceeds the allowed 60 SF, allowed per the Sign Ordinance, by approximately 148.70 SF. To note the Commission in the past has allowed incidental signage to be increased by way of a use permit, by applying Table 18.125.150-A, which states higher totals of identity signage require a use permit approval. However as stated, the Commission has with other similar projects, allowed an increase in the incidental signage through this section. The sign package has been attached for the Commission's review.

#### **Environmental Review and Analysis**

The project, new construction of a small structure, has been reviewed pursuant to the California Environmental Quality Act (CEQA). City staff has determined that the proposal is exempt from further CEQA pursuant to Section 15303 Class 3 (New Construction).

#### **Findings of Fact**

Based upon the facts and conclusions contained within this staff report the following findings must be made in order to approve the applicant's request for a Use Permit to allow the additional incidental signage:

- 1. The proposed use is consistent with the goals, objectives, policies and programs of the city of willows general plan and any applicable design guidelines.
- 2. The proposed use conforms to applicable development standards and provisions of this title and will not be detrimental to the public health, safety and welfare.
- 3. The physical location or placement of the use is compatible with the surrounding neighborhood and does not pose a safety risk.

In accordance with Section 18.135.030 notice of this public hearing was published in the local newspaper ten (10) days prior to the public hearing and all property owners as indicated on the latest secured Assessor's records within 400 feet of the subject property were sent notice of the hearing.

#### STAFF RECOMMENDATION:

Staff recommends the Commission review the proposal and if appropriate adopt the attached draft resolution recommending Design Review and Use Permit approval for a new Jack in the Box commercial building, site improvements and allow additional signage, subject to the conditions of approval as shown in Attachment #2.

#### PLANNING COMMISSION OPTIONS:

- 1) Recommend approval of the Design Review & Use Permit proposal and subject to Conditions of Approval as described in Attachment 2
- 2) Deny the Design Review and Use Permit applications with appropriate findings for denial

#### **Attachments:**

- 1. Draft Planning Commission Resolution
- 2. Proposed Conditions of Approval
- 3. Applicant statement
- 4. Site Plan/Elevations/Landscape plans
- 5. Signage Plan
- 6. Zoning & General Plan Map

Submitted by:

Karen Mantele Principal Planner

THE APPLICANT IS REMINDED THAT THERE IS A 10 (TEN) DAY APPEAL PERIOD FOLLOWING THE PLANNING COMMISSION DECISION ON THE USE PERMIT PURSUANT TO Chapter 18.135.060

## **Site Photos**



Former Bldg on back lot (2018)



Former buildings on front lot



**Looking north** 



**Looking south across Wood Street** 

#### **DRAFT**

#### PC RESOLUTION NO. \_\_\_\_\_--2021

A RESOLUTION OF THE PLANNING COMMISSION OF THE CITY OF WILLOWS GRANTING DESIGN REVIEW APPROVAL FOR A NEW 2,739 SF COMMERCIAL BUILDING AND SITE IMPROVEMENTS FILE # DR-21-02 AND USE PERMIT APPROVAL FOR 148.70 SF OF ADDITIONAL INCIDENTAL SIGNAGE FILE #UP-21-03 TO TBS HOLDINGS LLC FOR THE PROJECT LOCATED AT 1240 W WOOD STREET ASSESSORS PARCEL NUMBERS 001-041-014 & 001-041-015

**WHEREAS,** the applicant, PM Design on behalf of the property owner TBS Holdings, LLC has filed for Design Review approval to allow a new 2,739 SF commercial building with site improvements; and,

**WHEREAS**, City of Willows Municipal Code Section 2.45.030 requires all new commercial buildings and physical improvements obtain Design Review approval, and,

**WHEREAS**, City of Willows Municipal Code Section 18.125.150 establishes signage requirements and allows for additional square footage with an approved Use Permit; and

**WHEREAS,** notice of the Planning Commission meeting held on July 21, 2021, was published in a newspaper of general circulation in the City in accordance with law, and mailing to property owners within 400 feet were sent; and,

**WHEREAS,** the Planning Commission did, on July 21, 2021, hold a public hearing to consider all public oral and written comments, letters and documents, staff reports, and all other documents and evidence which are a part of the Record; and,

**WHEREAS,** the Planning Commission has reviewed all evidence submitted in connection with the application, including public testimony, staff report, supporting documentation, City codes and regulations, and all other relevant documents and evidence which are part of the record of proceedings; and,

**WHEREAS**, the Planning Commission finds that the proposal is considered exempt from the California Environmental Quality Act (CEQA) pursuant to Section 15303 New Construction, Class 3; and,

**WHEREAS**, the Planning Commission does finds that the proposed use (additional signage) is consistent with the purposes of the district (HC) in which the site is located,

- a) as the proposed business is a restaurant allowed within the zoning district, and signage to advertise their products is essential in selling the product;
- b) The Commission finds that allowing 148.70 square feet of additional incidental signage under Section 18.125.150 is allowed for the new business with use permit approval.

**WHEREAS**, the Planning Commission does find that the proposed use is consistent with the goals, objectives, policies and programs of the City of Willows general plan, as restaurants are permitted to advertise their products, which the applicant is requesting additional signage to do so; and,

**WHEREAS,** the Planning Commission does find that the proposed use conforms to applicable development standards and provisions of this title and will not be detrimental to the public health, safety and welfare, as conditions of approval shall provide for the signs to adhere to the codes, and standards; and,

**WHEREAS**, the Planning Commission does find that the physical location or placement of the use (incidental signage) is compatible with the surrounding neighborhood and does not pose a safety risk as the signage shall abide by the conditions adopted for the project.

**NOW THEREFORE, BE IT RESOLVED**, that the Planning Commission of the City of Willows does hereby find that the Design Review proposal to allow the construction of a new commercial building with site improvements and Use Permit proposal for additional signage is consistent with the City of Willows Municipal Code and General Plan, and findings incorporated, and hereby approves Use Permit #UP-21-03 And# DR-21-02, subject to the attached conditions of approval set forth in Attachment #2.

**IT IS HEREBY CERTIFIED** that the foregoing Resolution was duly adopted at a regular meeting of the Planning Commission of the City of Willows on Wednesday, the 21<sup>st</sup> day of July 2021 by the following vote, to wit:

AYES			
NOES			
ABSTAIN			
ABSENT			
		APPROVED:	
		ANTRO VED.	Hilgard Muller, Chairperson
ATTEST:			
	Maria Ehorn	Recording Secretary	

#### File#UP-21-03 & DR-21-02 CONDITIONS OF APPROVAL FOR JACK IN THE BOX PROJECT FOR PROPERTY LOCATED AT 1240 W WOOD STREET APN(S): 001-041-014 & -015

PC approv	al date:	,2021
PC approv	ai date:	,202

#### General

- 1. That the applicant/developer shall enter into a Pass Through Agreement with the City of Willows to pay the cost of all planning review, plan checking and field inspection of this development.
- 2. If the use (*additional incidental signage*) is not made on the project subject to the permit within one (1) year after the date of granting the permit, then without further action, the permit shall be null and void, and such use shall not be made of the property except upon the granting of a new permit.
- 3. All plans for additional uses, which are not covered by this review, shall be submitted to the City Manager/Planning Commission for review and approval prior to use.
- 4. The Architectural Design Review approval shall expire in one year unless otherwise stipulated by the Planning Commission. The applicant may apply to the City for an extension of not more than one year from the original date of expiration, if found that there has been no substantial change in the factual circumstances surrounding the originally approved design. Substantial changes and any further extension beyond one year shall require Planning Commission approval.
- 5. The developer shall adhere to the design and specification of the Architectural Design Review approval for the exterior façade improvements, to include the proposed material/color scheme of the new building, compliant parking spaces, landscaping, signage, trash enclosure and necessary site improvements as shown on the plans submitted with the application. An occupancy permit shall not be issued in part or whole for any building or group of buildings subject to design review unless and until the work specified in the design review approval has been completed, including landscaping. If for any valid reason full compliance cannot be made; a cash bond shall be posted for the work to be completed within a reasonable period of time as determined by the City Manager or his authorized representative.
- 6. A revised sign package shall be submitted. Any new business signage shall require sign permit approval from the Planning Department prior to installation. Any sign requiring building permit approval shall obtain one prior to installation of sign.
- 7. All building mounted and site lighting shall be shielded lights, down lights, and or full cut off lights so that the bulb is not visible from off-site and light does not create glare or hazard onto adjoining properties/streets. Cut sheets shall be submitted with building plans. All lighting must meet the City Standards.
- 8. All landscaping shall be maintained in good condition and any dead or dying plants, bushes, or trees shall be replaced with new healthy stock of a size compatible with the remainder of the growth at the time of replacement.
- 9. The approval of this project shall be subject to the latest adopted Ordinances, Resolutions, Policies and fees of the City of Willows.

- 10. In the event that archaeological remains or artifacts are uncovered during construction activities, work shall be stopped, and a qualified archaeologist shall survey the site. The archaeologist shall submit a report with recommendations of the disposition of the site. Disposition may include, but is not limited to, excavation and documentation, capping the site, or leaving the site in an open space area. The recommendations of the archaeologist shall be incorporated in the project.
- 11. All contractors/sub-contractors doing work on the project shall obtain a City business license prior to commencing work.

#### **Building Department**

- 12. If you intend to construct, enlarge, alter, repair, move, demolish, or change the occupancy of the building or structure or to erect, install, alter, repair, remove, convert, or replace any electrical, gas, mechanical or plumbing system, the installation of which is regulated by code, or to cause any such work to be done, you shall first make application for a building permit and obtain the required permit for the development.
- 13. Applicant shall submit a completed building permit application with detailed scope of work, 3 complete sets of plans, calculations, specifications, etc. for review. Appropriate plan review fees shall be paid at the time of submittal.
- 14. All work shall comply with current applicable Federal, State, local building codes and ordinances and be shown on the plans submitted for building permit review.
- 15. Conditions of approval shall be shown on the plans submitted for building permit review.
- 16. Prior to issuance of a Building Permit for the construction of any structures on the site, a Final Lighting Plan shall be submitted to the City and reviewed by the Engineer. The final lighting plan shall include, but not limited to the following: (a) details regarding exterior lighting with lighting sources that are full cut-off, hooded, and down-cast, or otherwise shielded to ensure that light does adversely shine towards neighboring properties or toward the night sky, (b) lighting sources with the minimum wattage necessary to provide adequate security without causing excessively bright night glow, (c) sufficient details regarding the proposed wattage and area of coverage for all site lights.

#### **Fire Department**

- 17. Development impact fees are applicable to this project and shall be paid prior to the issuance of a building permit.
- 18. All buildings will have fire sprinkler systems provided. The Fire Department shall review all sprinkler plans prior to installation. WMC 15.15.110
- 19. All fire and security alarm systems must meet the approval of the Fire Chief. WMC 15.15.120.
- 20. The Site shall be equipped with a Knox box holding a master key. WMC 15.15.130
- 21. Shall provide fire extinguishers in accordance with the 2019 CFC.

- 22. The building address shall meet all WMC 15.15.100 criteria and be reviewed and approved by the Fire Department prior to installation. An illuminated address sign shall be provided for the property.
- 23. Provide illuminated exit signs over all exit doors in accordance with the 2019 CBC and CFC.
- 24. Red curbs maybe required and will be reviewed at the time of construction/development of project.
- 25. All exit doors shall have no knowledge door locks, be posted "this door to remain unlocked when building occupied" and swing in the direction of exit travel.
- 26. Water flow calculations shall be provided after the installation of new hydrant to indicate that they meet water flow requirement minimums for this development.
- 27. On-site hydrant's will be required to have dedicated right-of-way easements to Cal Water and will follow Cal Water design and planning process.
- 28. FDC connection will be within 50' of hydrant and shown on site plan.
- 29. All utility rooms will need to be identified by signage.

#### **CalWater Service**

30. Need more information on water plans. An existing 2" service is currently on site. Will need additional fire service and hydrant onsite if required. Main is on opposite side of Wood Street. Will require Fire Dept sign off if hydrant is required.

#### **County of Glenn Environmental Health**

31. Recommend approval with the comment that all proposed food facilities must submit plans to Glenn County Environmental Health for review and approval before any construction can begin. Any questions can be directed to <a href="mailto:environmental@countyofglenn.net">environmental@countyofglenn.net</a> or 530.934.6102.

#### **Cal Trans**

- 32. Please provide a site plan that shows State Right of Way GLE 162/WEST WOOD ST. Please show the distance to the centerline. Advise identifying any possible vulnerable survey monuments in the development area that will need to be preserved and or/perpetuated, as required by PE Act 6731.2 and PLS Act 8771. Contact <a href="mailto:D3rwmaprequest@dot.ca.gov">D3rwmaprequest@dot.ca.gov</a> for any right of way map request/information needs.
- 33. Current driveways exist along site, with neither driveway exceeding the 35ft maximum width as specified in the Highway Design Manual (HDM) 205.3 Given the approximately 165 feet property frontage the total driveway width is expected to be within limits found in HDM 205.3.
- 34. The existing sidewalk/driveways are exhibiting signs of fatigue (cracking and possibly uneven settling). We recommend complete replacement of sidewalk/driveways, regardless of their current condition, exiting sidewalks/driveways must be checked for slopes and possibly other variable for conformance with ADA standards.
- 35. An encroachment permit will be required for any work, including but not limited to, work on sidewalks/driveways, that is withing the State Highway right-of-way. To apply, provide the application form, five sets of plans and local agency approval with environmental determination to the Encroachment Permits office at 703 B Street, Marysville, CA 95901, Attn Encroachment Permits.

#### **Engineering Department:**

#### **General Conditions:**

- 36. Developer shall design and construct all improvements and facilities shown on the design review plans submitted for permit approval in accordance with the Willows Municipal Code (WMC), the City of Willows Design and Construction Standards. Approval of a design review site plans depicting improvements that do not conform to the WMC or City standards does not constitute approval of an exception to the WMC or City standards unless explicitly stated herein or in another City resolution.
- 37. The developer shall be responsible for all City plan check, map check and inspection costs. The developer shall deposit funds with the City upon the initiation of plan check services. The amount of the initial deposit shall be determined by the City Engineer. Additional funds may be required based upon actual plan check and inspection costs.
- 38. Site improvement plans shall be prepared and submitted by a California Registered Civil Engineer for the construction of all necessary and required on-site and off-site improvements including grading, water, sanitary sewer, storm drain facilities, roadway improvements, curbs, gutters, and sidewalks. All design and construction shall conform to the City of Willows Design and Construction Standards, as applicable.
- 39. A detailed Soils Investigation/Geotechnical Report shall be prepared and submitted for review. The report shall address, at a minimum, potential for liquefaction, expansive soils and seismic risk. The improvement plans shall incorporate all design and construction criteria recommended in the Geotechnical Report.
- 40. All private water mains, sewer mains and storm drains shall be clearly labeled "Private" on the improvement plans.
- 41. The improvement plans shall show removal of the large pylon posts at the southwesterly corner of Parcel 1 (3 PM 81).
- 42. A lot merger shall be recorded prior to the issuance of a building permit.
- 43. Improvements plans shall include a storm water pollution prevention plan. Erosion control measures shall include hydroseeding of all graded slopes within 60 days of completion of grading.
- 44. Driveways into the proposed development shall be installed per the City's most recent standards and shall conform to the most recent ADA standards. If the sidewalk associated with the driveways must encroach onto private property outside of the right-of-way, pedestrian public access easements shall be provided by separate document and shall be recorded prior to issuance of a building permit.
- 45. Any work within the State right-of-way shall require a Caltrans encroachment permit. Proof of Caltrans' issued encroachment permit shall be required prior to issuance of a building permit for the project.
- 46. All sidewalk that is current cracked or displaced shall be replaced with the construction of the project.

- 47. All existing utilities shown on the site plan that conflict with the proposed new buildings (water, gas, electric, telephone, etc.) shall either be removed or properly abandoned. The improvement plans for the proposed project shall indicate removal or abandonment.
- 48. There appears to be an existing monitoring well located in the sidewalk fronting the project. The improvement plans shall indicate the disposition of this monitoring well (whether it will remain in place or be properly abandoned.) If it is to be abandoned, evidence of permission to abandon shall be provided to the City prior to issuance of a building permit, as well as required abandonment procedures.
- 49. The proposed pylon sign shall be installed such that it will not interfere with sight distance from either the property associated with this project, or the driveway entrance abutting the westerly property line.

#### **Water and Sanitary Sewer Improvements:**

- 50. Any existing sewer lines on the property that will not be used by the new project shall be abandoned and backfilled.
- 51. The project shall include installation of a grease separator prior to connection to the sewer main. If there is a proposed sewer lateral serving only restrooms, that sewer lateral does not have to be connected to the grease separator.
- 52. Sewer grades must be designed such that ultimate finished floors are a minimum of 12" above upstream manhole or clean-out rim elevations. Inadequate elevation differentials or grade on private laterals, as determined by the City, must be mitigated by either raising finished floor elevation(s) or installation of a backflow check valve.

#### **Drainage Improvements:**

53. All project related flooding impacts shall be mitigated by the project developer. Drainage improvements shall be designed in accordance with the Design Criteria utilizing the rationale method and any applicable adopted City drainage plans.

The applicant shall submit for review and approval, drainage plans and hydraulic calculations prepared by a Registered Civil Engineer. The drainage plans and calculations shall indicate the following conditions before and after development:

- **a.** Quantities of water, water flow rates, major water courses, drainage areas and patterns, diversions, collection systems, flood hazard areas, sumps, and drainage courses.
- **b.** Post-development off-site flows shall not exceed pre-development flows.
- 54. Low Impact Development (LID) improvements shall be provided for on the plans along with calculations submitted with the first plan check of the improvement plans.
- 55. All existing easements shall be shown on the plans. If existing easements are provided for the benefit of other parcels, either the proposed improvements shall preserve the easements or shall provide new easements prior to the issuance of a building permit.
- 56. No grading or other construction shall be performed until the improvement plans have been approved and signed by the City Engineer. Encroachment Permits and Building Permits will not be issued prior

- to the approval of the improvement plans. An Encroachment Permit is required for any work within the City's rights of way.
- 57. The developer shall keep adjoining public streets free and clean of project dirt, mud, materials, and debris during the construction period, as is found necessary by the City Engineer.
- 58. If any hazardous waste is encountered during the construction of this project, all work shall be immediately stopped and the Glenn County Environmental Health Department, the Fire Department, the Police Department, and the City Inspector shall be notified immediately. Work shall not proceed until clearance has been issued by all of these agencies.
- 59. Where soil or geologic conditions encountered in grading operations are different from that anticipated in the soil and/or geologic investigation report, or where such conditions warrant changes to the recommendations contained in the original soil investigation, a revised soil or geologic report shall be submitted for approval by the City Engineer. It shall be accompanied by an engineering and geological opinion as to the safety of the site from hazards of land slippage, erosion, settlement, and seismic activity. Additionally, if field conditions warrant installation of any subdrains, the location, size and construction details must be provided to the City for review and approval prior to construction.
- 60. All streets, curbs, gutters, sidewalks, or other public facilities damage in the course of construction associated with this development shall be the responsibility of the Developer and shall be repaired to the satisfaction of the City at the Developer's expense.
- 61. Dust control must be maintained to the City's satisfaction.
- 62. Working hours shall be restricted to the hours of 7:00 a.m. to 6 p.m., Monday through Friday.
- 63. Developer shall provide sufficient surety guaranteeing the public improvements for a period of one year.



PM Design Group, Inc 6930 Destiny Dr., Ste. 100 Rocklin, CA 95677 P: 916.415.5358 F: 916.303.4330

March 31, 2021

Karen Mantele City of Willows Planning 201 N. Lassen Street Willows, CA 95988

RE: Jack in the Box; 1240 W. Wood Street - Project Description

Dear Ms. Mantele:

The project proposes constructing a new 2,739 sq. ft. Jack in the Box restaurant with a double drive-thu. The finishes on the exterior will be a mixture of stucco, tile, and branding panels. These branding panels are a Jack in the Box trademark look which have colored backlighting that creates a soft "glow" appearance, and the color can be changed based on the time of day. The parapets will be built to a height to screen the existing rooftop equipment. The height will vary to give the building additional dimension. LED lighting will also add to the appeal of the elevations. ADA accessible parking stalls and path of travel from the public right-of-way will also be installed. The look has a contemporary clean feel that will enhance the experience of the patrons and the appearance of the overall neighborhood.


Business conducted on the site is the typical fast-food restaurant with drive-thru. Hours of operation are Monday-Sunday 6:00am-Midnight for the Dining Room area, and 24 hours operation for the drive-thru. Number of employees on largest shift is eight.


Thank you, Greg Borchardt PM Design Group



# STORE #4387 MK9S\_MD NEW BUILD 1240 W. WOOD STREET WILLOWS, CA 95988



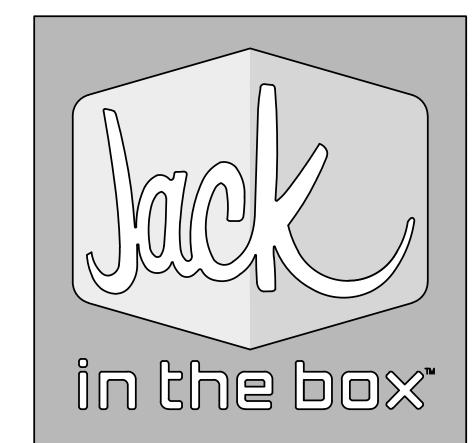


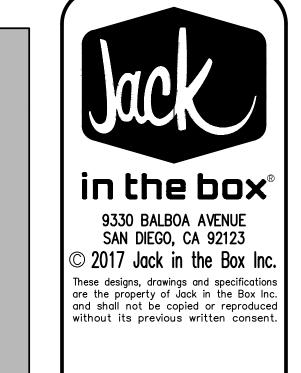


DATES

OCT. 02, 2017

LEGEND & ABBREVIA	TIONS	GENERAL NOTE	PROJECT DESCRIPTION	SHEET INDEX (TOTAL OF 16 SHEETS)	SUBMITTAL DATE: 1:
ALSO REFER TO LEGEND & ABBREMATIONS ON CIVIL, STEP, PLUMENN NO CONDUT OF PPING MILL BE PERMITTED TO PROFITE THE TO PROFING MILE BY PERMITTED TO PROFITE SELL OR TOP PLATE. SEE PLANS FOR ADDITIONAL NOTES.  BATT INSULATION  RIGID I	G, MECHANICAL, ELECTRICAL & KITCHEN DRAWINGS.  HORR BOLT  HALT  HALT  HORR BOLT  HALT  HALT  HORR BOLT  HALT  HALT  HALT  HORR BOLT  HALT  MAX.  MAX.	GENERAL NOTE  1. IN THE LIVENT OF DISCREPANCES BETWEN THE DRAWINGS OR SPECIFICATIONS, IN THIS PACKAGE, NOTIFY ARCHITECT IMMEDIATELY.  2. ARCHITECT SHALL NOT BE RESPONSIBLE OR NATE CONTROL OR CHARGE OVER ACTS OR ONE THE SAFETY PRECAUTIONS & PROGRAMS OF THE CONTRACTOR, SUBCONTRACTOR, OR CONTROL OR CHARGE OVER ACTS OR ONE ANY DITHER PERSONS PERFORMING WORK ON THE PROJECT.  3. ARCHITECT HAS NOT BEEN EXTANDE FOR REVEW SUPERVISION OR ADMINISTRATION OF THE OWNER'S REPRESENTATIVE MILL REVIEW THE PROJECT.  4. CONTRACTOR IS RESPONSIBLE TO SEE THAT WORK IN THE FIELD IS DONE IN ACCORDANCE WITH PROJECT OF A WILL PROJECT OF A WILL REVIEW THE PROJECT A RENDER MECCHSSARY DECISIONS FOR THE PROJECT OF A WILL REVIEW THE PROJECT A RENDER MECCHSSARY DECISIONS FOR THE PROJECT OF A WILL REVIEW THE PROJECT A RENDER MECCHSSARY DECISIONS FOR THE PROJECT OF A WILL REVIEW THE PROJECT A RENDER MECCHSSARY DECISIONS FOR THE PROJECT ON THE PROJECT OF THE PROJECT OF A WILL REVIEW THE PROJECT A RENDER MECCHSSARY DECISIONS FOR THE PROJECT OF THE	THE PROPOSED PROJECT CONSISTS OF THE CONSTRUCTION OF A NEW 2,739 SD, FT, JACK IN THE BOX RESTARRANT MITH BRIWE—THRU LOCATED AT 1240 M. WOOD STREET MILLONS, CA.  ON SITE WORK MILL INCLIDE LANDSCAPING, ADA PARRING AND PATH OF TRAVEL TO THE PUBLIC RICHT OF MAY, A NEW TRASH ENCOSURE. AND BUILDING STRAKE.  PROPOSED USES/ACTIMITES THAT MILL OCCUR NUSDE THE BUILDING JAKE TYPICAL RESTAURANT/FAST FOOD DINNG. ACTIVITES WHICH INCLIDE PREPARATION OF FOOD, TAKE—OUT/JURIVE—THRU TRANSACTIONS AND SEATED DINNG.  PROPOSED USES/ACTIMITES THAT MILL OCCUR OUTSIDE THE BUILDING INCLUDE A DRIVE—THRU LANG, OUTSIDES PARRING, AND TRASH PICK—UP.  HOURS OF OPERATION ARE WOODAY—SUIDANY 6-000AH—MONIGHT FOR THE DINNG ROOM AREA, AND 24 HB. OPERATION FOR THE DRIVE—THRU.  TOTAL NUMBER OF EMPLOYEES: 4-5 TOTAL  TOTAL	TSI.0 TITLE SHEET  CI.0 GRADING & DRAINAGE PLAN  SDO.0 AERIAL SITE PLAN AND PHOTOS  SDI.1 SITE PLAN  SDI.1 EXTERIOR LICHTING DETAILS  SDI.2 SITE DETAILS  LI LANDSCAPE PLAN  LI LANDSCAPE PLAN  AI.0 PROPOSED FLOOR PLAN  AA.1 PROPOSED EXTERIOR ELEVATIONS  A4.1 PROPOSED EXTERIOR COLOR ELEVATIONS  A4.2 PROPOSED EXTERIOR COLOR ELEVATIONS  A4.3 PROPOSED EXTERIOR COLOR ELEVATIONS  A5.0 BUILDING SECTIONS  DI.0 PROPOSED SEATING PLAN  VICINITY MAP  VICINITY MAP	1:
I.B.C. INTER  I.D. INTER  I.D. INTER  I.D. INCH	ERNATIONAL BUILDING CODE ERIOR DESIGN I DRMATION ERIOR ERTED IT K in the Box, Inc. ET ELE ENDS			Glenn Medical Center W  Sunited States Postal Service Fu Hing Chinese	TITLE SHEET  TS1.0

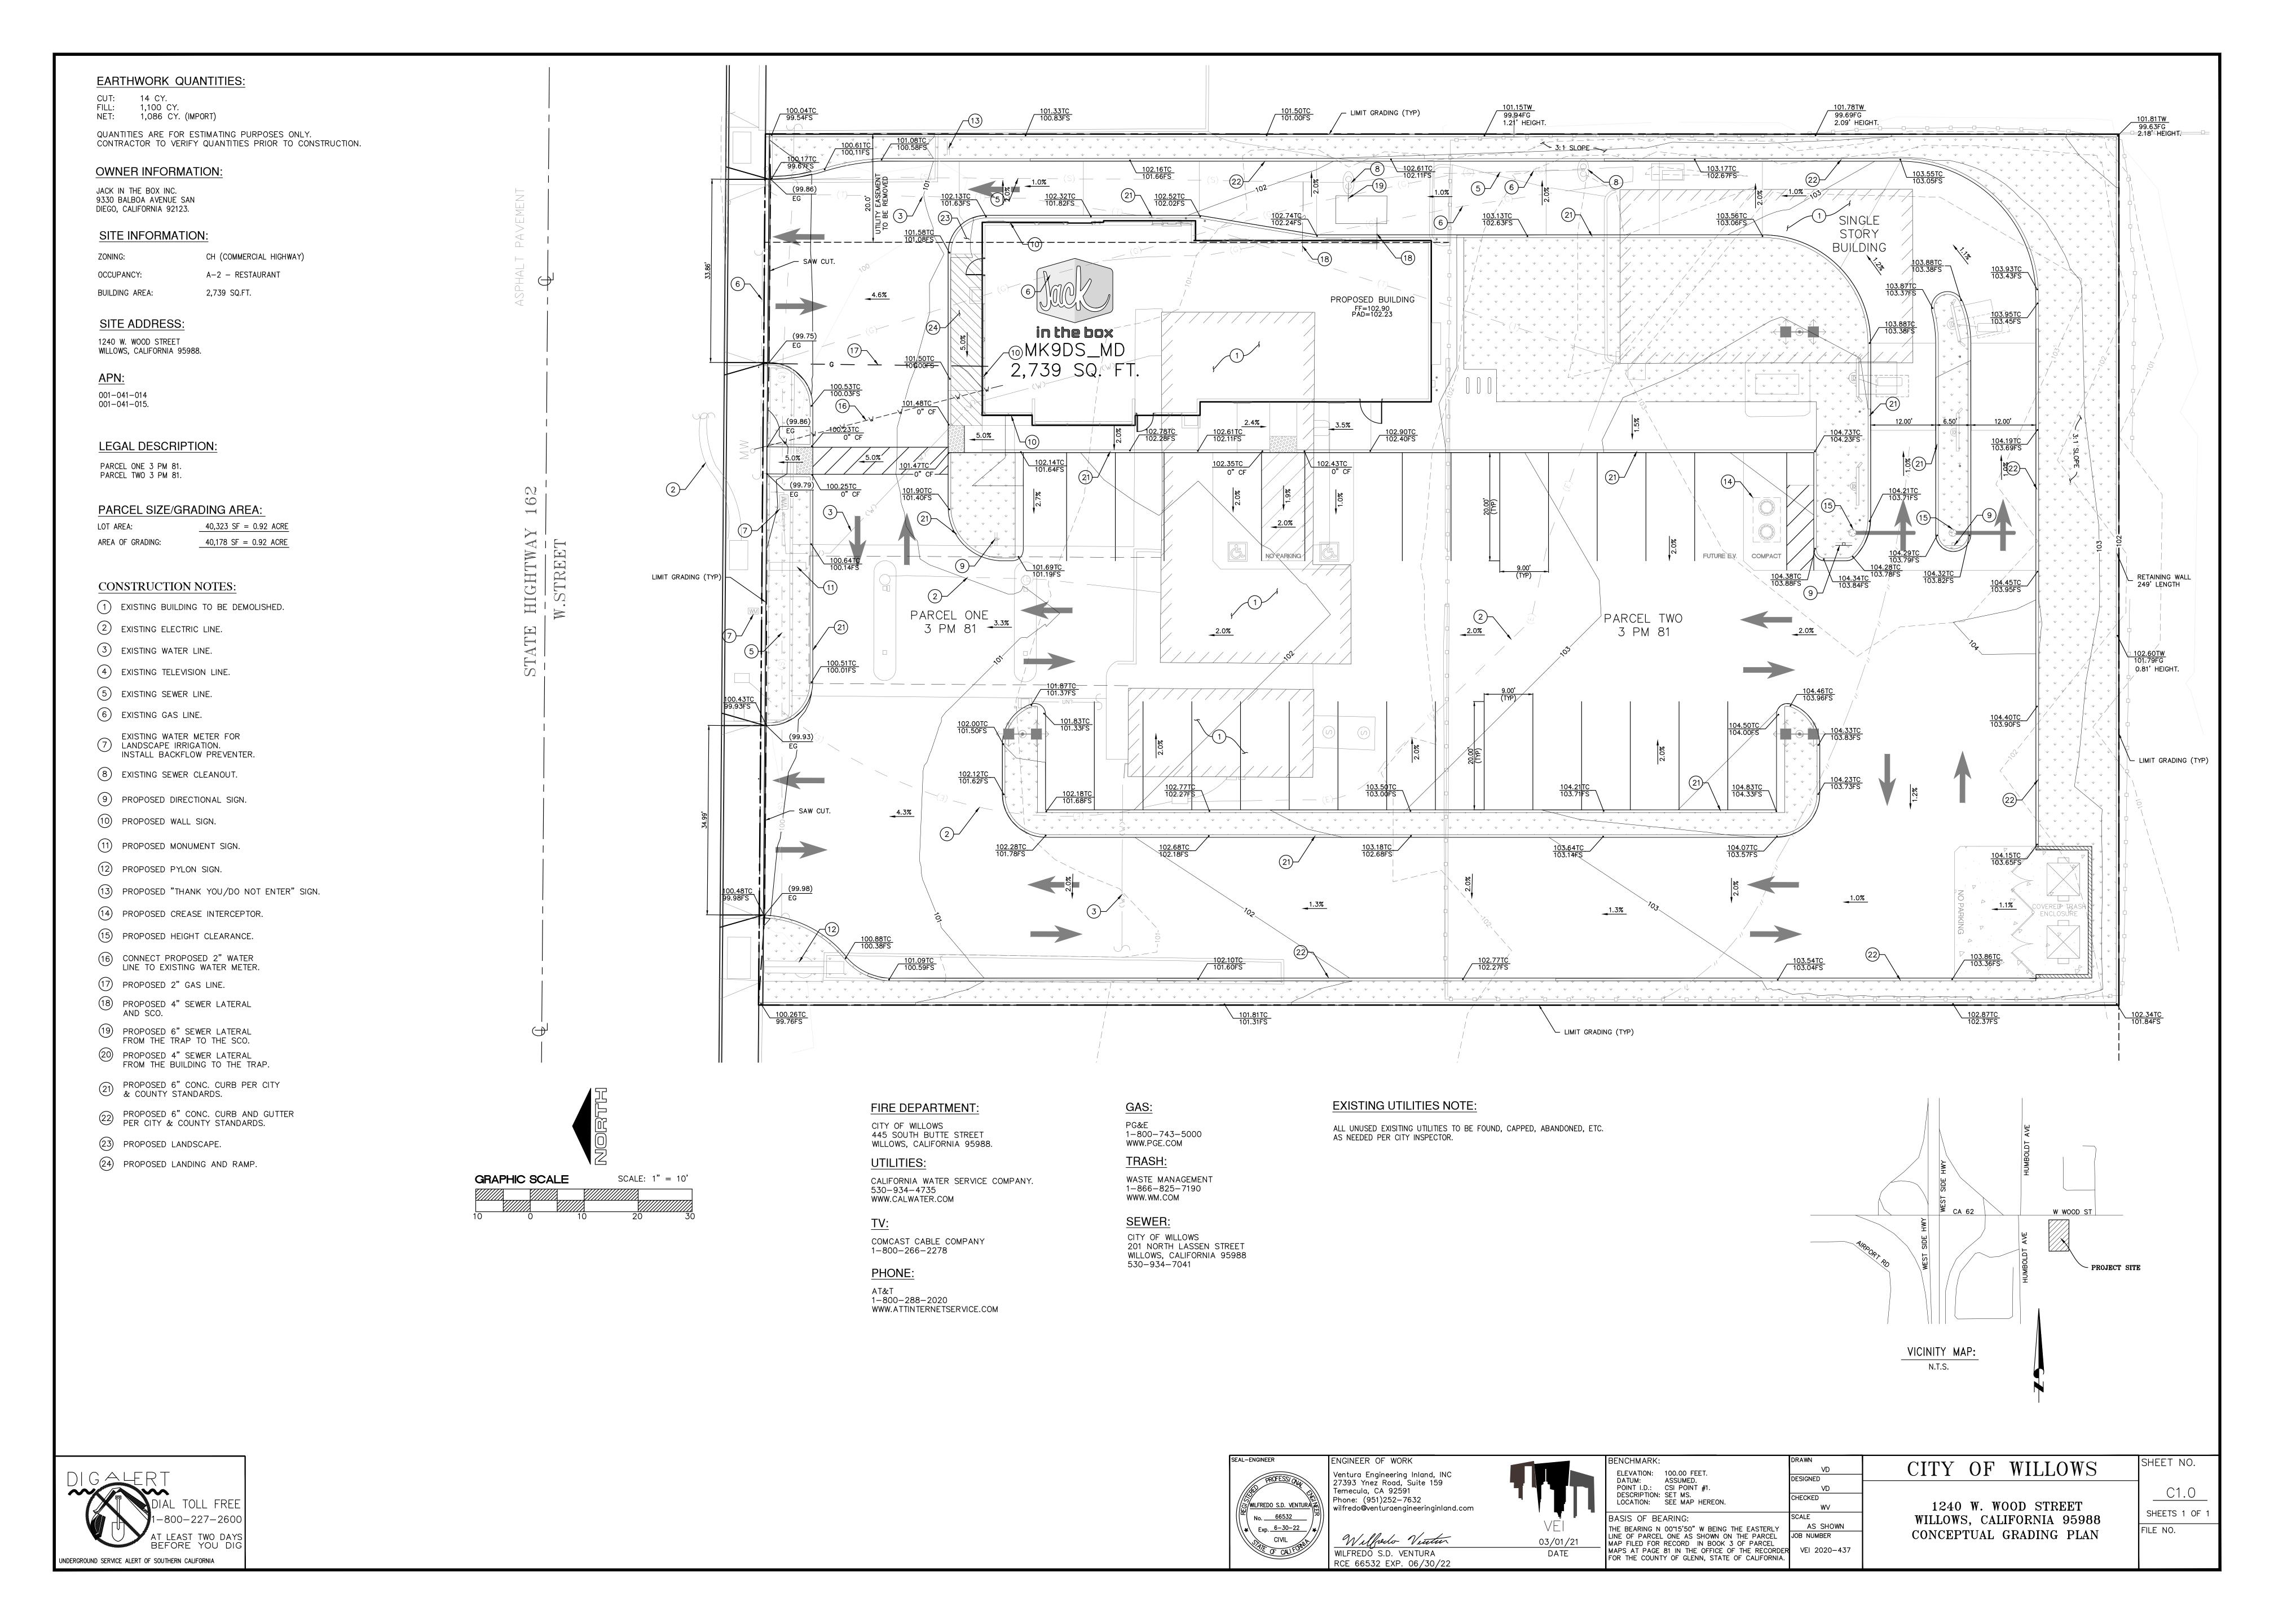

# PLANT SCHEDULE

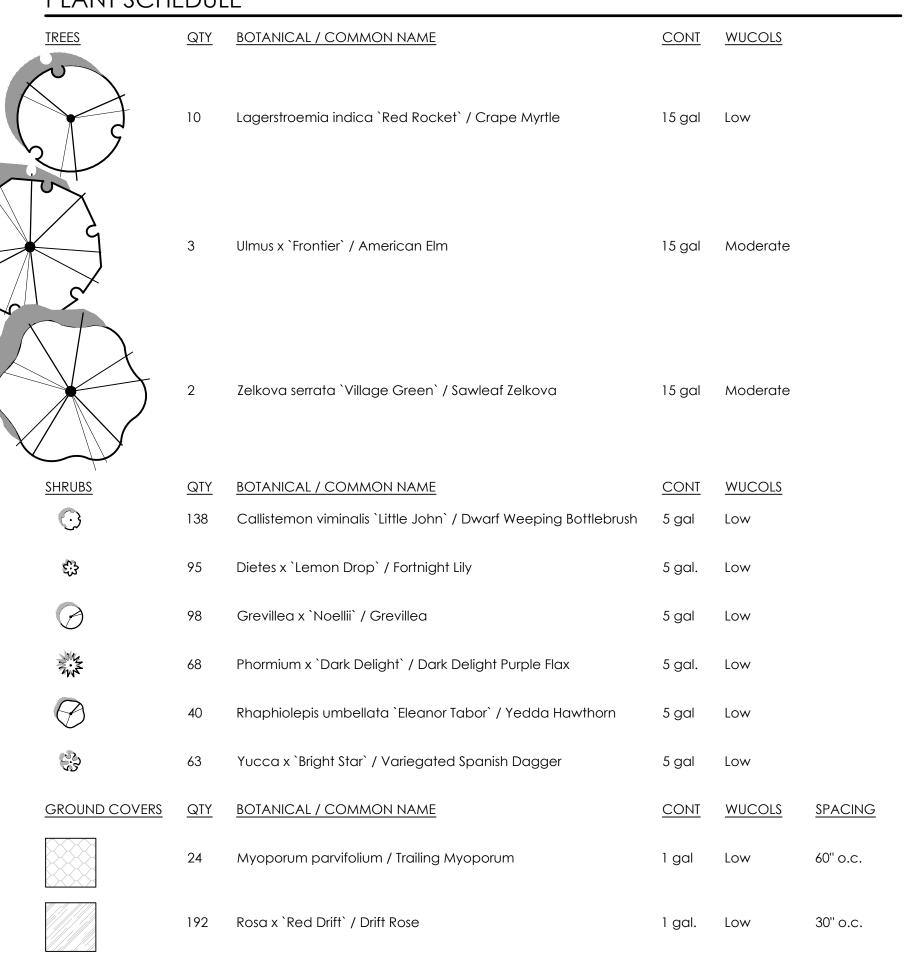

# GENERAL NOTES

- 1. All landscape planting areas shall receive a minimum 3" layer of organic mulch top dressing.
- 2. All trees, shrubs and groundcover shall be irrigated with a drip system, smart controller, weather sensor, etc.and shall meet City of Willows Water Efficient standards/regulations.

SCALE: 1/16" = 1'-0"


3. All new trees located within 7' of pavement or permanent structure shall have a root barrier.

# COMPLIANCE STATEMENT

I have complied with the criteria of the water use ordinance and applied them accordingly for the efficient use of water in the landscape design plan.



3-4-21

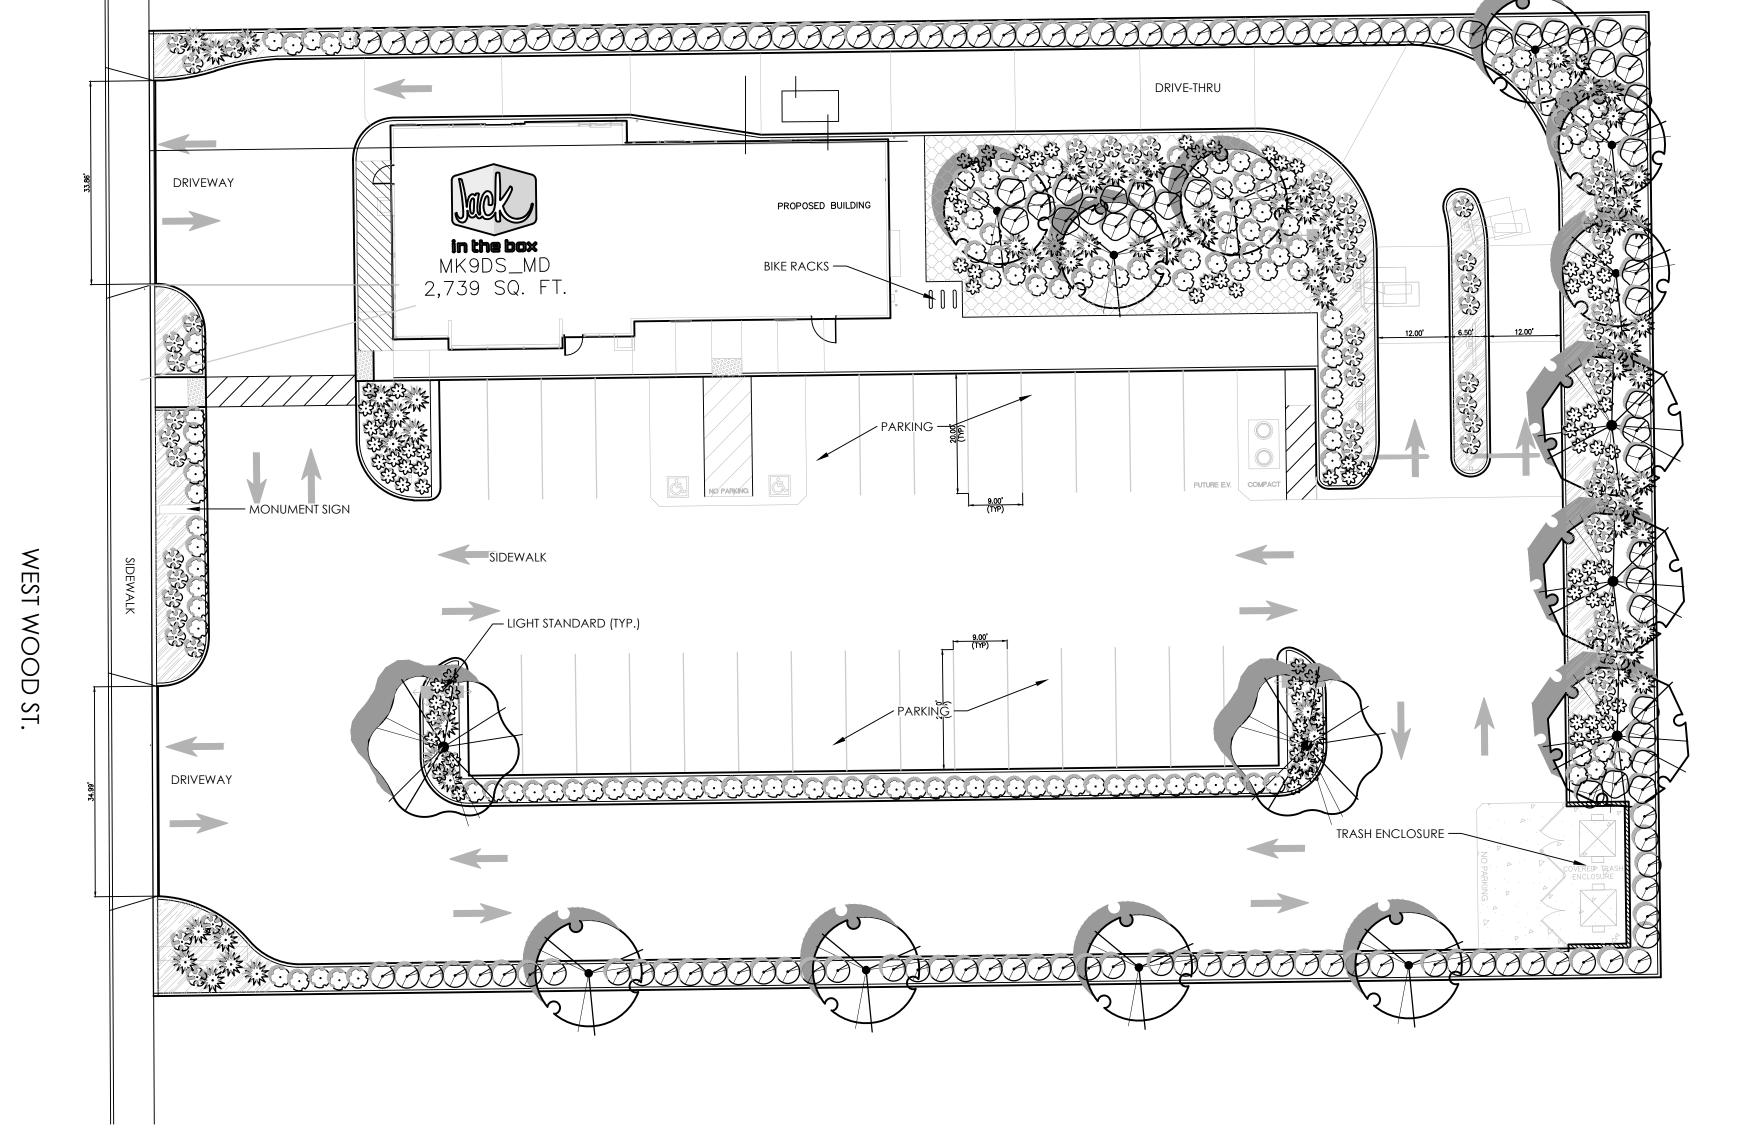

# Water Efficient Landscape Worksheet

HYDROZONE/PLANTING DESCRIPTION	PLANT FACTOR (PF)	IRRIG. METHOD	IRRIG. EFFICIENCY (IE)	ETAF (PF/IE)	LANDSCAPE AREA (Sq. Ft.)	ETAF x AREA	ESTIMATED TOTAL WATER USE (ETWU)
REGULAR LANDSCAPE AREA							
LOW WATER USE PLANTS	.3	DRIP	.81	.37	8,305	3,073	97,740 GAL.
MODERATE WATER USE PLANTS	.5	DRIP	.81	.62	125	78	2,481 GAL.
				TOTALS	(A) 8,430	(B)3,151	
					E	TWU Total	100,221GAL.

Maximum Applied Water Allowance (MAWA). MAWA= (ETo) (Conversion factor) ((ETAF)(Landscape Area)) + ((1-ETAF) x SLA) (51.3) (.62) (.45 x 8,430) + (1-.45) X 0) = 120,656 GALLONS

Estimated Total Water use (ETWU). ETWU= (ETO)) (Conversion factor) ((ETAF) (Area)) (51.3) (.62) (3,151) = 100,221 GALLONS

# ETAF Calculations

Regular Landscape Areas

Total ETAF x Area	(B) 3,151	
Total Area	(A) 8,430	
Average ETAF	(B / A) .37	

Note:
1. Average ETAF for Regular Landscape
Areas must be below .55 for residential
areas and .45 for non-residential areas.



SAN DIEGO, CA 92123

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DATES

 RELEASE:
 OCT. 02, 2017

 P.M. UPDATES:
 SEPT. 27, 2019

SUBMITTAL DATE:

1:\_\_\_\_

2:\_\_\_\_\_ 3:\_\_\_\_

CONSTRUCTION:

REVISIONS

^ ^ \_\_\_\_\_\_

OLIVE STREET

P.O. Box 2083
Petaluma CA 94952
707-280-8990
OliveStreetLandscape.com

rod@olivestreetlandscape.com





(916) 415-5358 rpedro@pmdginc.com

6930 DESTINY DRIVE SUITE 100 ROCKLIN, CA 95677

Roy W. Pedro, Architect

SITE INFORMATION

MK TYPE: MK9DS\_MD

 MK TYPE:
 MK9DS\_MD

 JIB #:
 4387

ADDRESS: 1240 W. WOOD S

1240 W. WOOD ST. WILLOWS, CA 95988

DRAWN BY:


PROJECT #: WFM20001.0

SCALE: 1" = 16'

LANDSCAPE PLAN

L1

# PLANT SCHEDULE

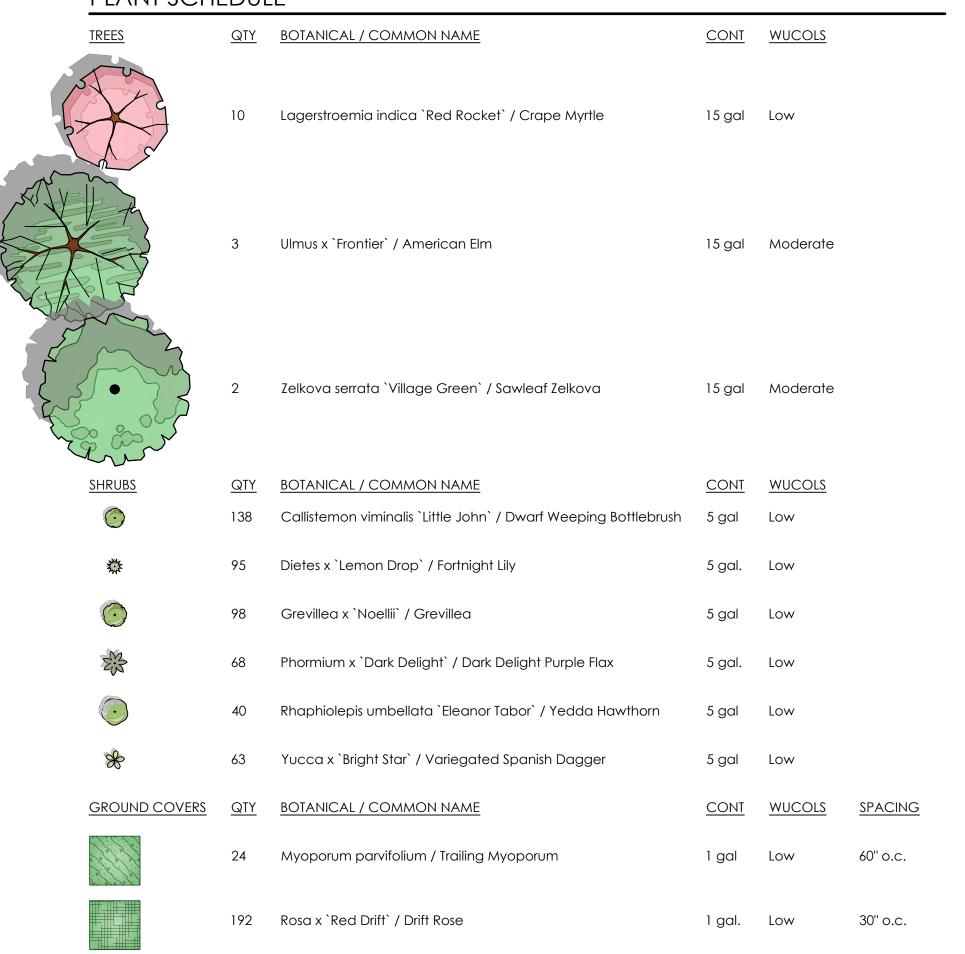




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DATES **RELEASE:** 0CT. 02, 2017

P.M. UPDATES: SEPT. 27, 2019

SUBMITTAL DATE:
1:\_\_\_\_\_

2:\_\_\_\_\_ 3:\_\_\_\_

CONSTRUCTION:

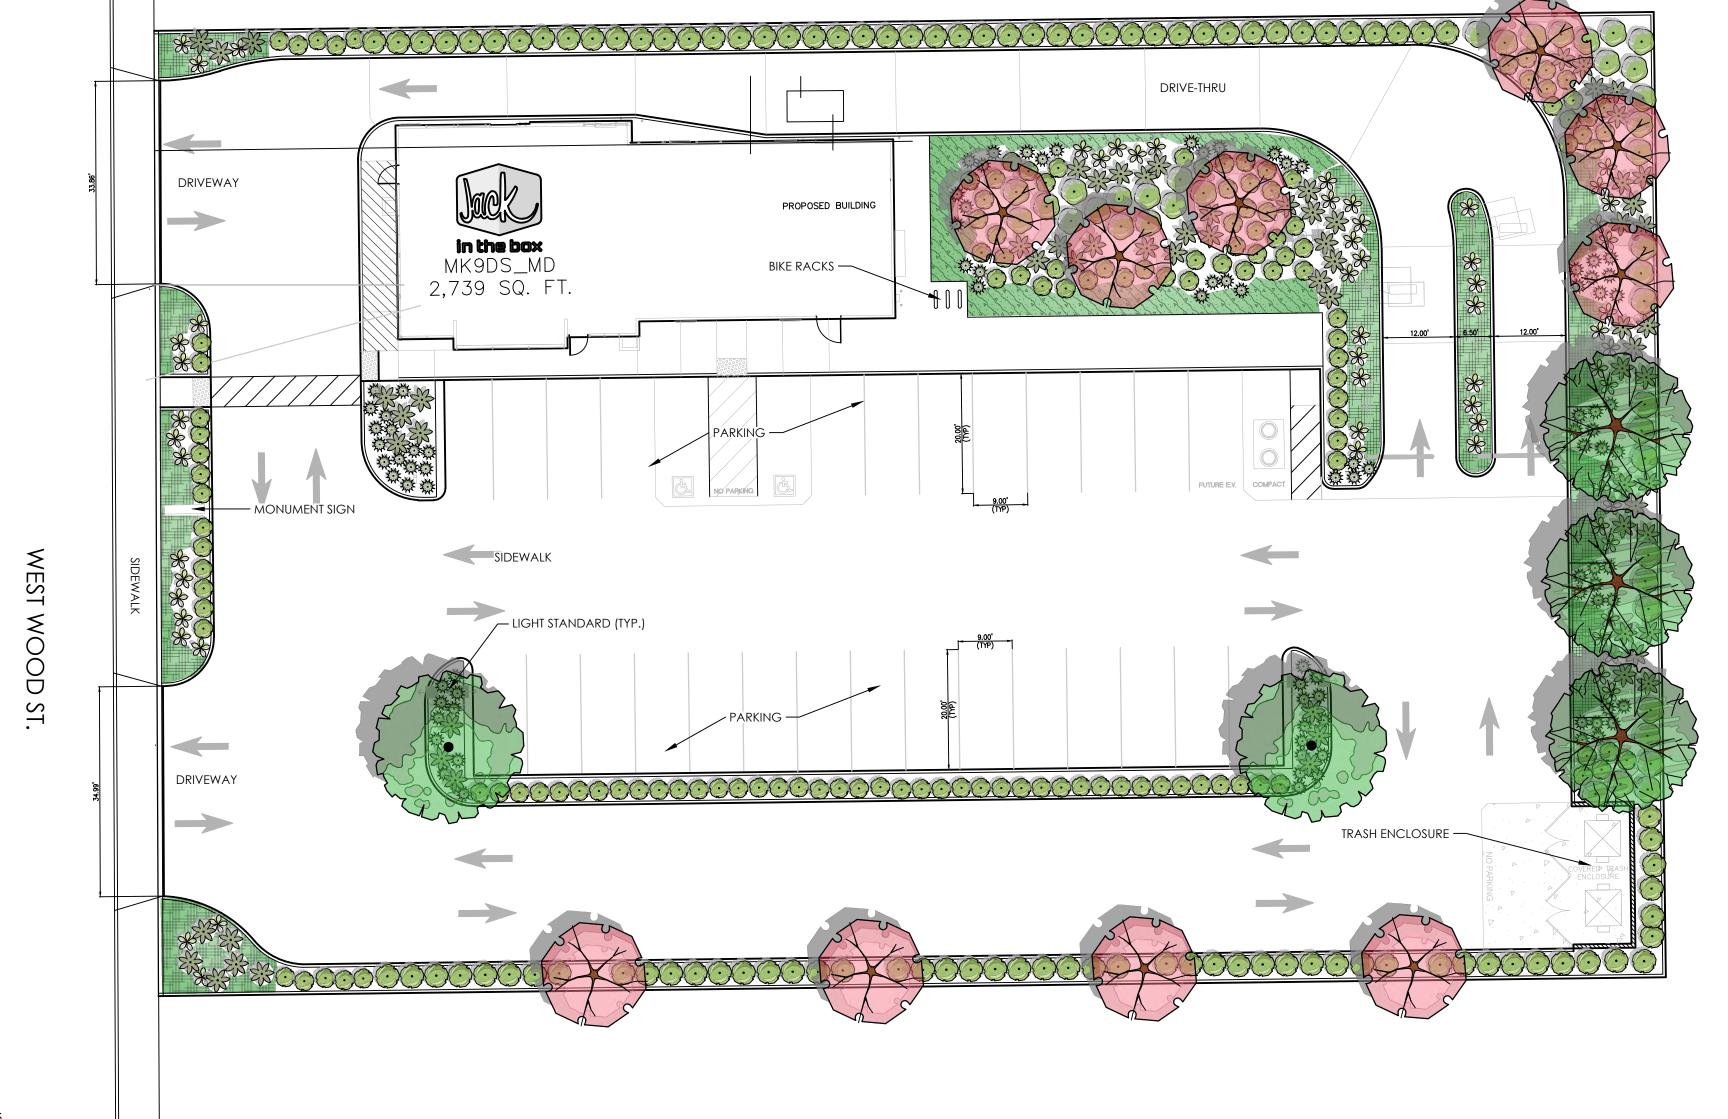REVISIONS

OLIVE STREET
LANDSCAPE ARCHITECTURE

P.O. Box 2083
Petaluma CA 94952
707-280-8990
OliveStreetLandscape.com
rod@olivestreetlandscape.com





(916) 415-5358 rpedro@pmdginc.com

SUITE 100 ROCKLIN, CA 95677

SITE INFORMATION

Roy W. Pedro, Architect

MK TYPE: MK9DS\_MD

JIB #: <u>4387</u>
ADDRESS:

1240 W. WOOD ST. WILLOWS, CA 95988


DRAWN BY:

PROJECT #: WFM20001.0

SCALE: 1" = 16'

LANDSCAPE PLAN

**L1** 

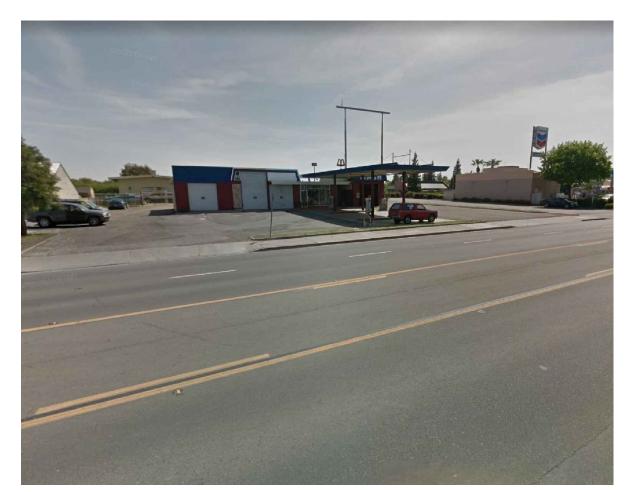











DATES SUBMITTAL DATE:

PHOTO 1 PHOTO 2 PHOTO 3 PHOTO 5 **PHOTO 4** 

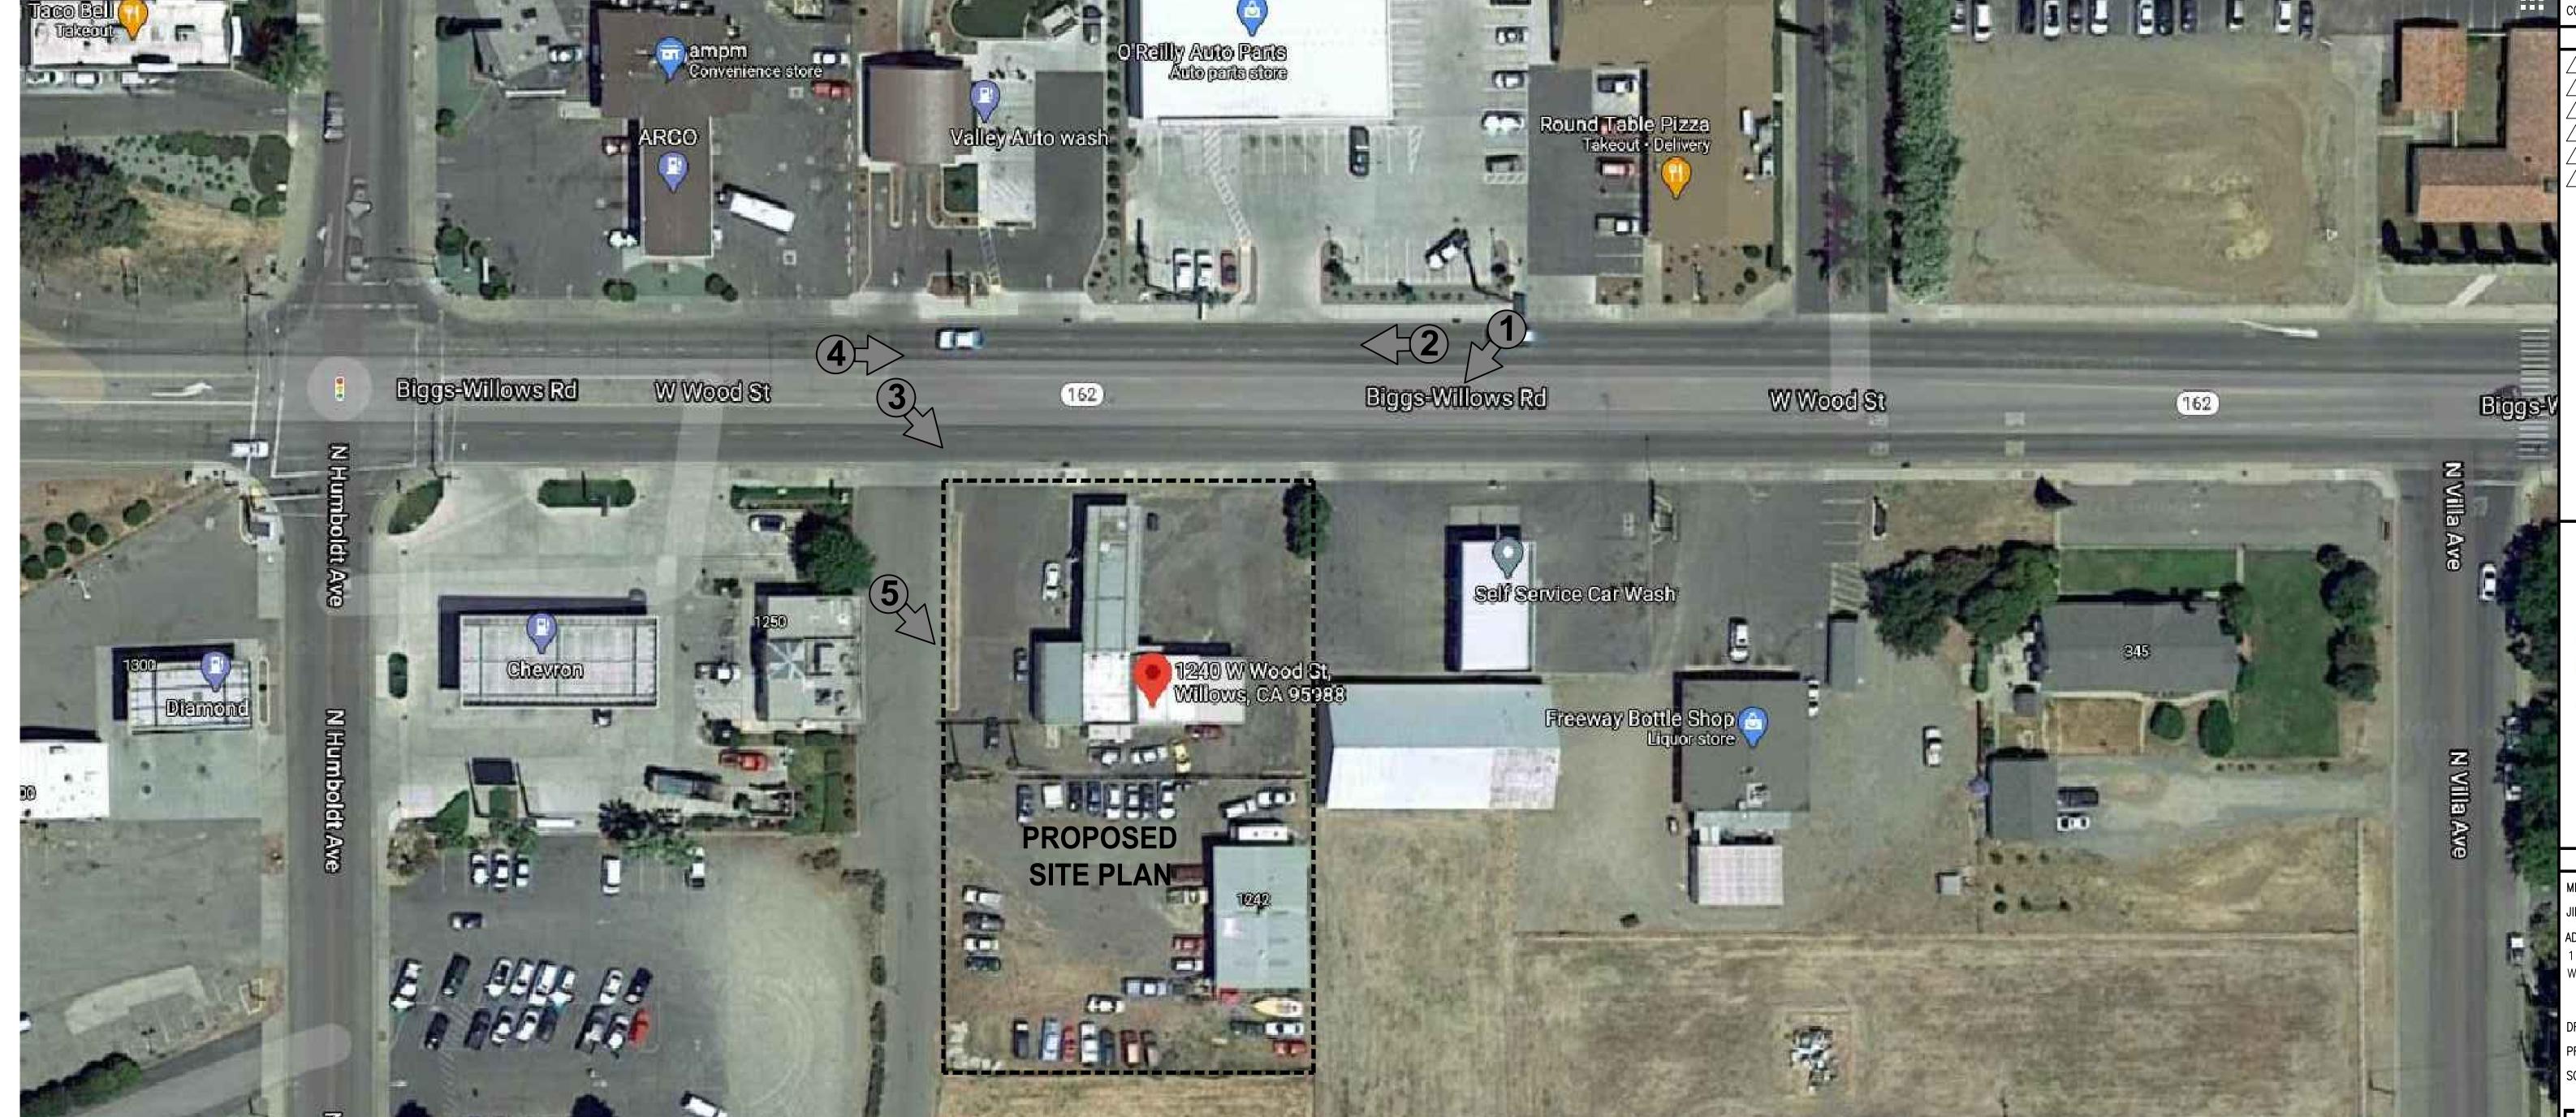



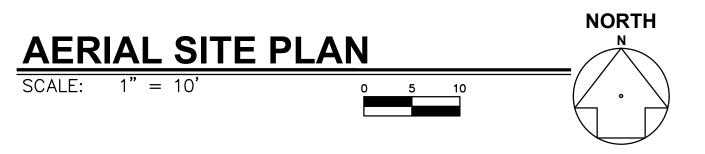

NOTE: SITE DEMO ARE UNDER SEPARATE PERMIT



OCT. 02, 2017 P.M. UPDATES: SEPT. 27, 2019

CONSTRUCTION:

REVISIONS



Solutions Group 6930 DESTINY DRIVE SUITE 100 ROCKLIN, CA 95677


Roy W. Pedro, Architect SITE INFORMATION


MK TYPE: MK9DS\_MD

1240 W. WOOD ST. WILLOWS, CA 95988

PROJECT #: WFM20001.0 SCALE: 1" = 20'

**EXISTING AERIAL** SITE PLAN AND PHOTOS **SD0.0** 

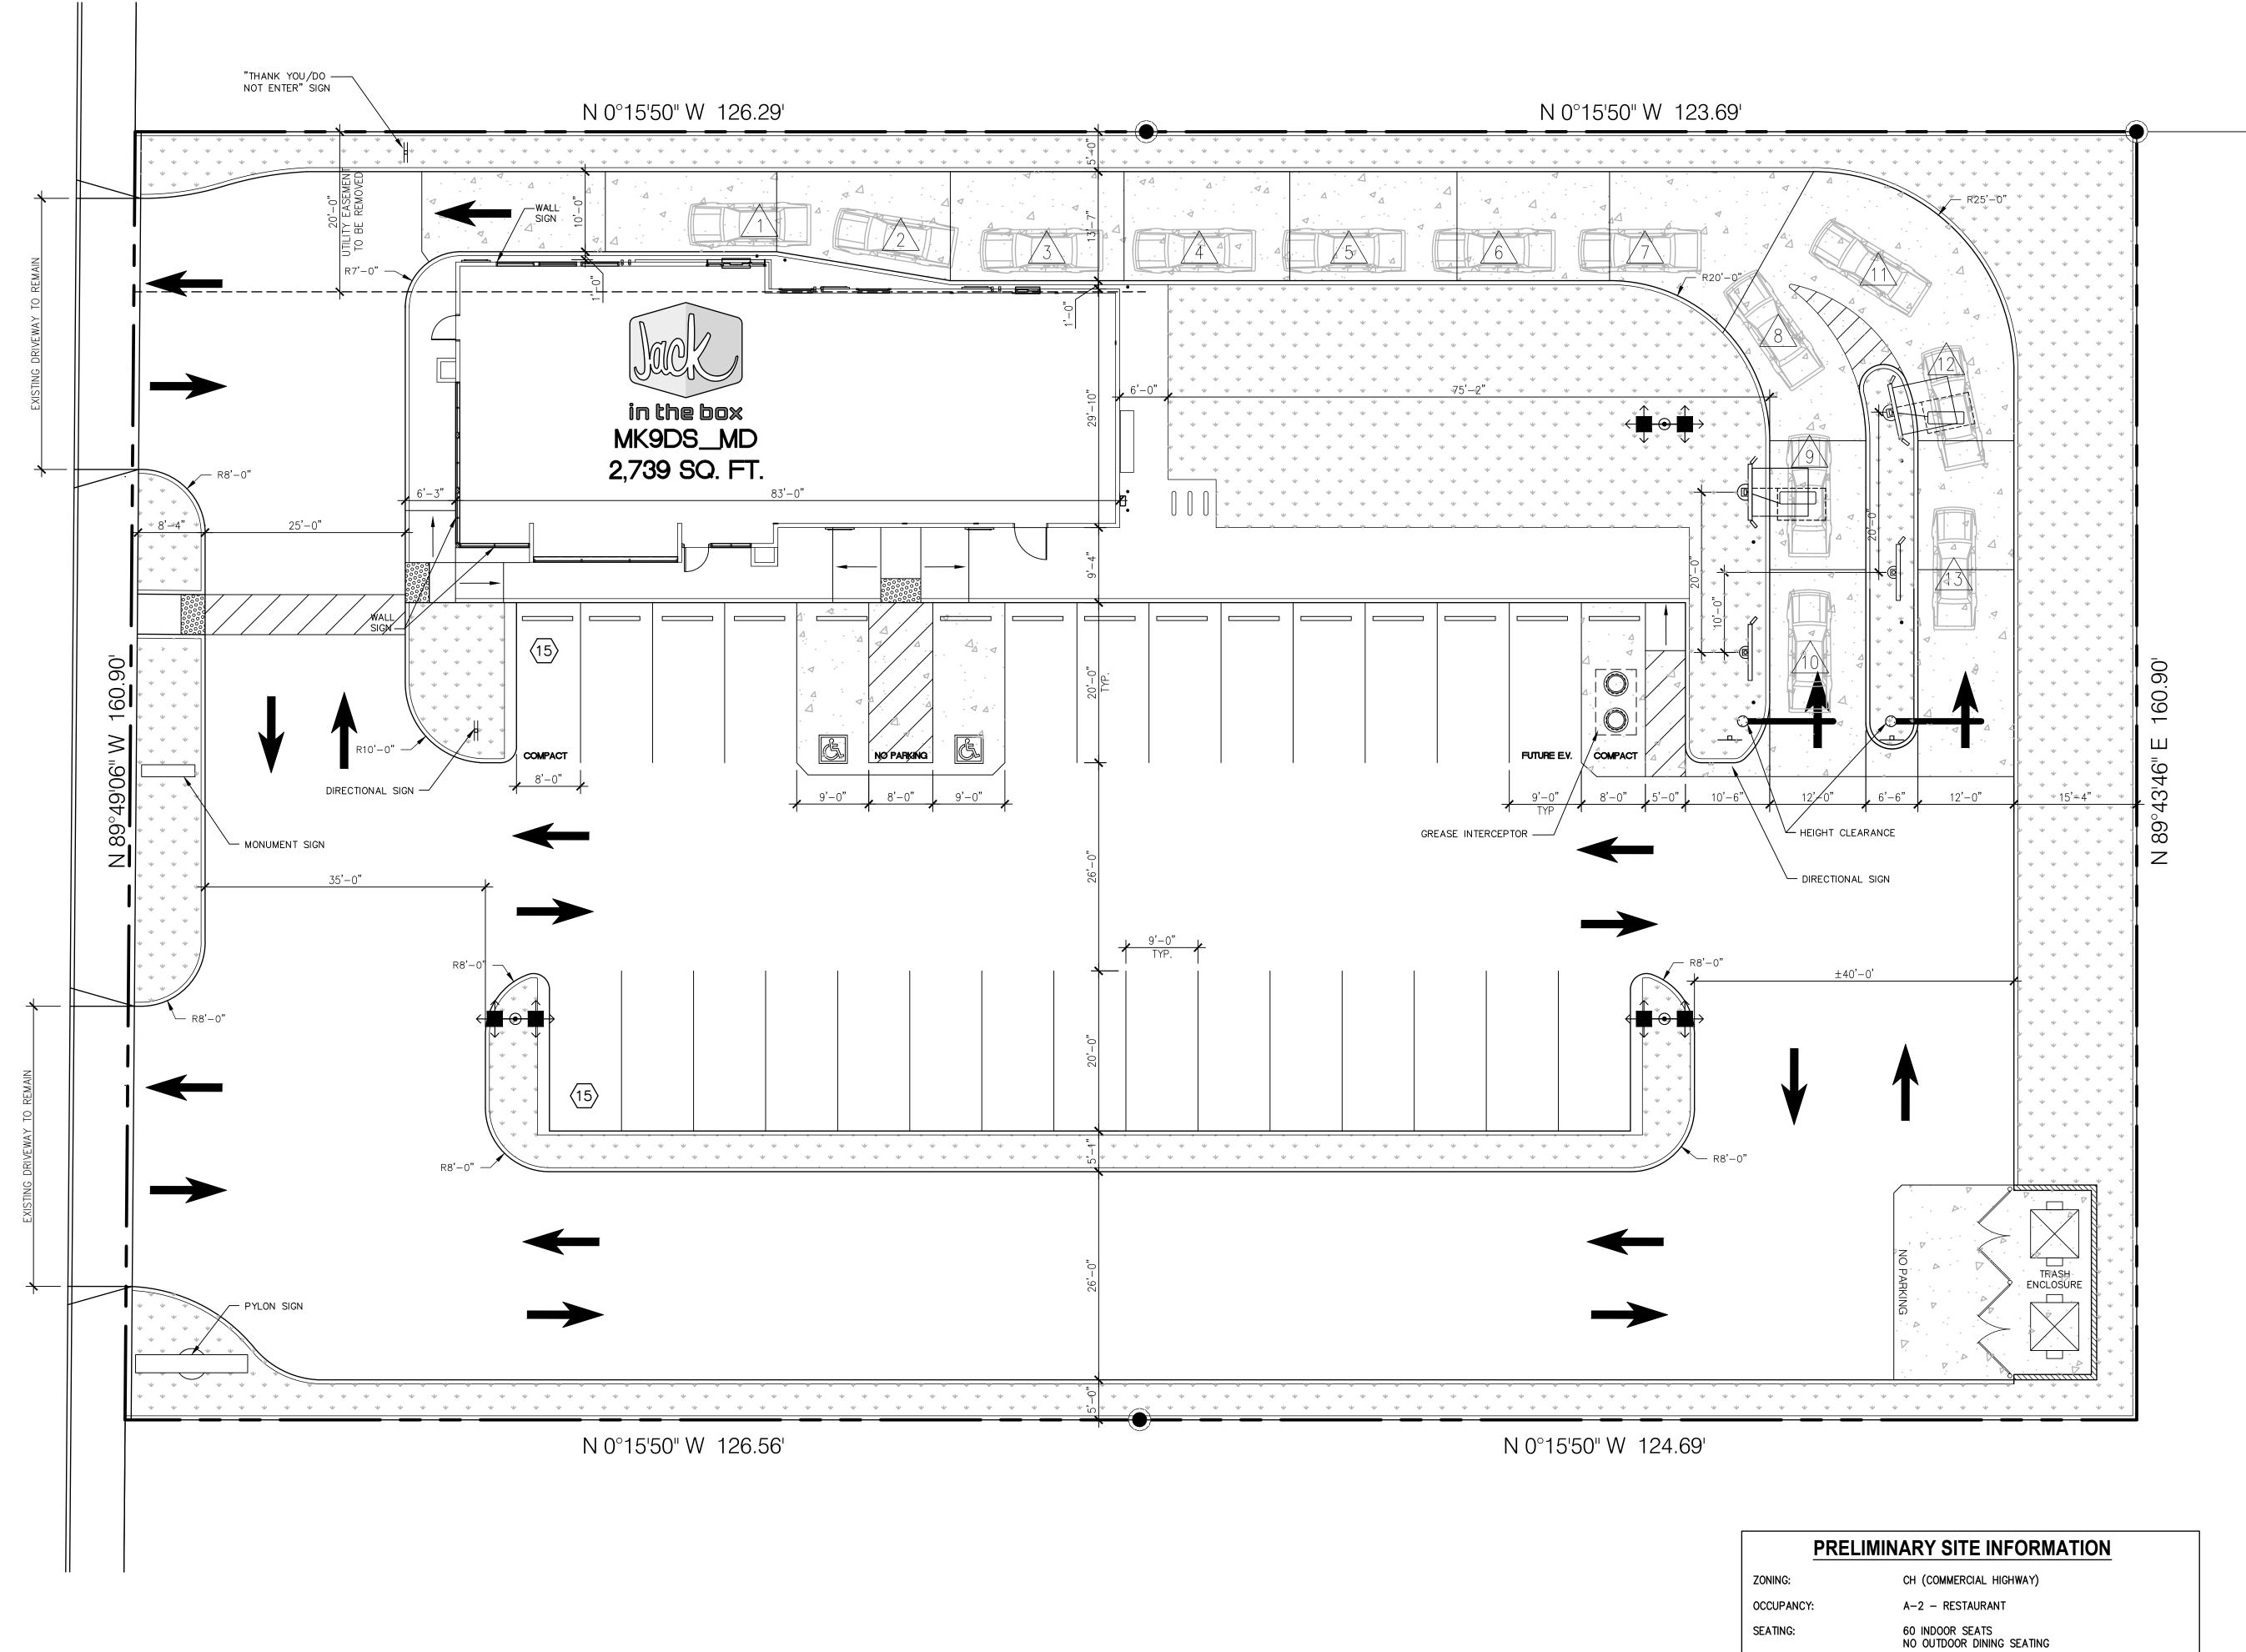

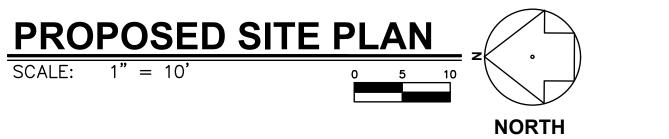



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DATES

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P.M. UPDATES: <u>SEPT. 27, 2019</u>

SUBMITTAL DATE:

**CONSTRUCTION:** 

REVISIONS





(916) 415-5358 rpedro@pmdginc.com

Roy W. Pedro, Architect

SITE INFORMATION

MK TYPE: MK9DS\_MD

JIB #: <u>4387</u>

ADDRESS: 1240 W. WOOD ST.

WILLOWS, CA 95988

DRAWN BY:

BUILDING AREA:

PARKING REQUIRED:

PARKING PROVIDED:

2,739 SQ.FT.

25 STANDARD SPACES
2 ADA ACCESSIBLE SPACES
2 COMPACT SPACES
1 FUTURE E.V. SPACES


30 TOTAL SPACES


1 SPACE PER 200 SQ. FT. = 2739/200 = 13.7 SPACES


PROJECT #: WFM20001.0


SCALE: 1" = 10'

**PROPOSED** SITE PLAN

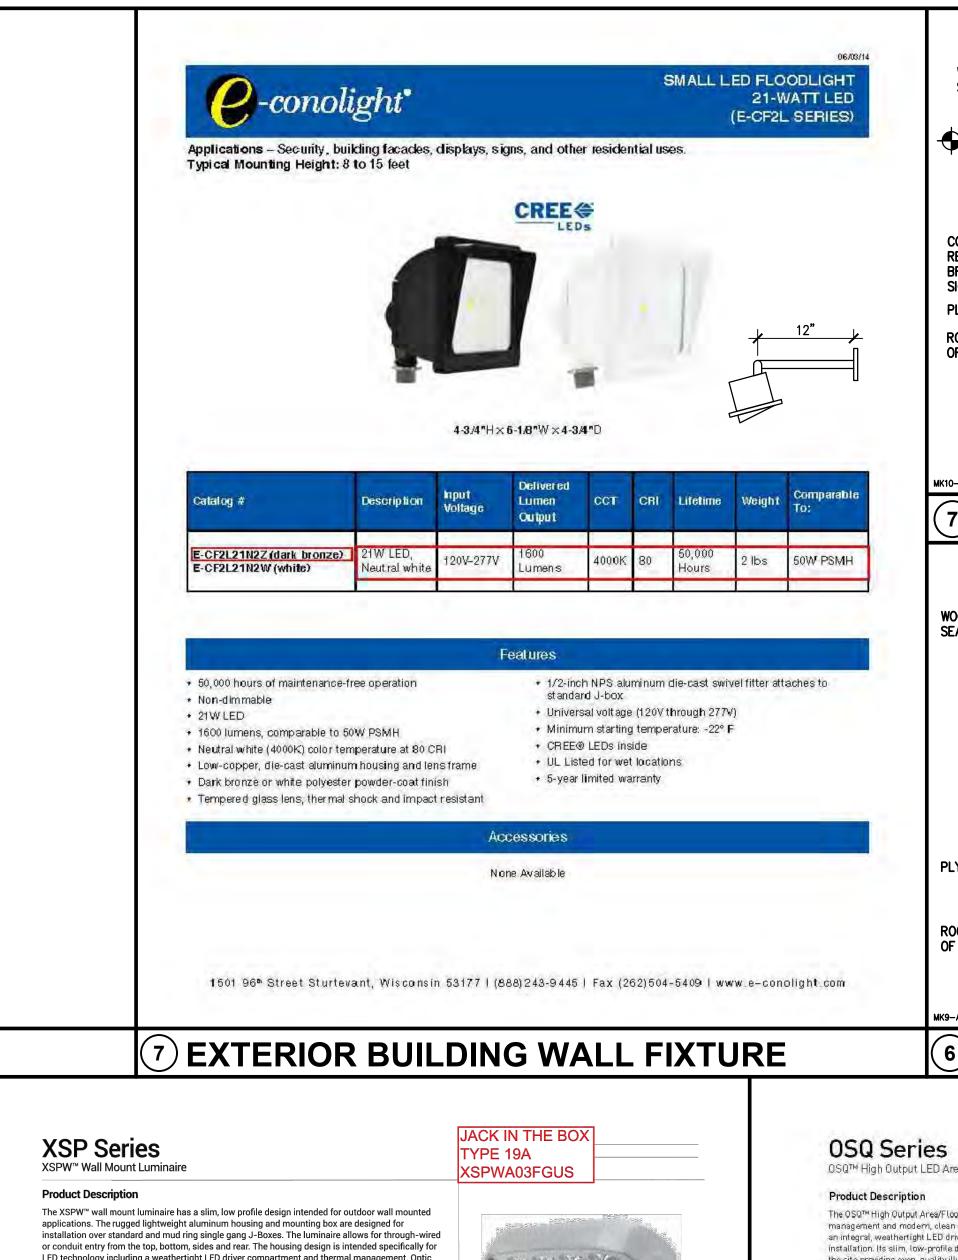


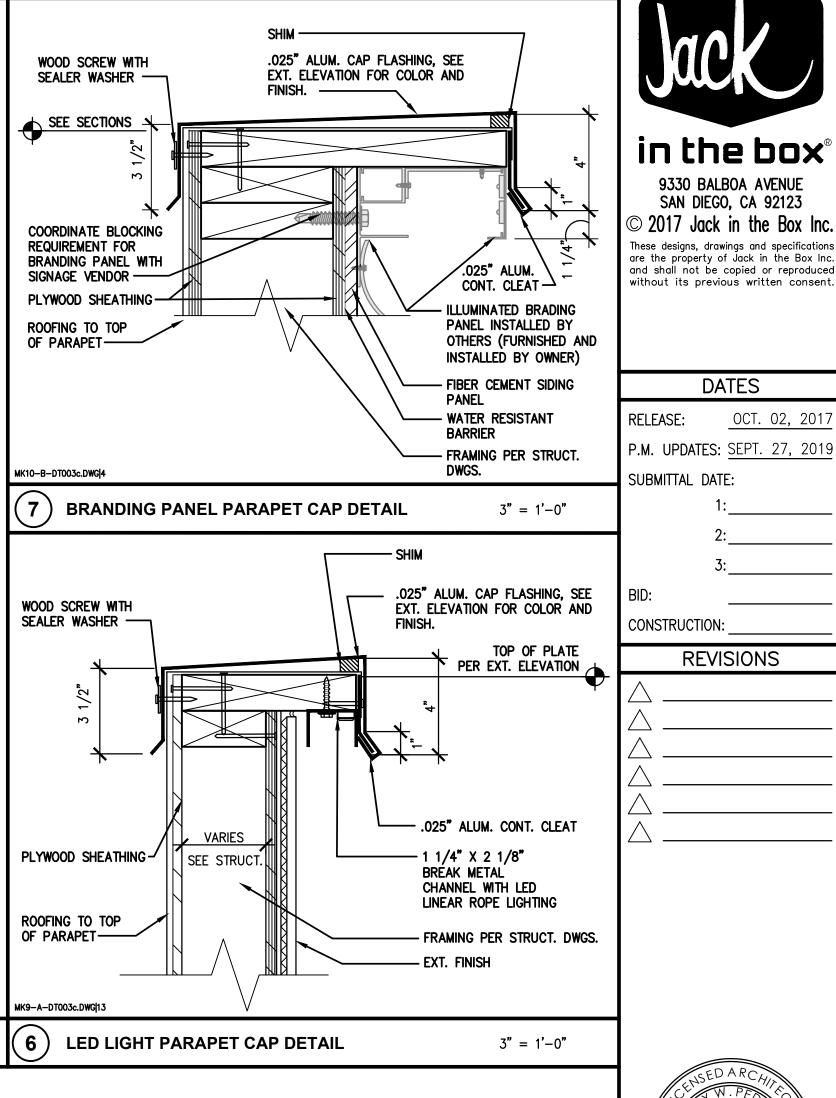


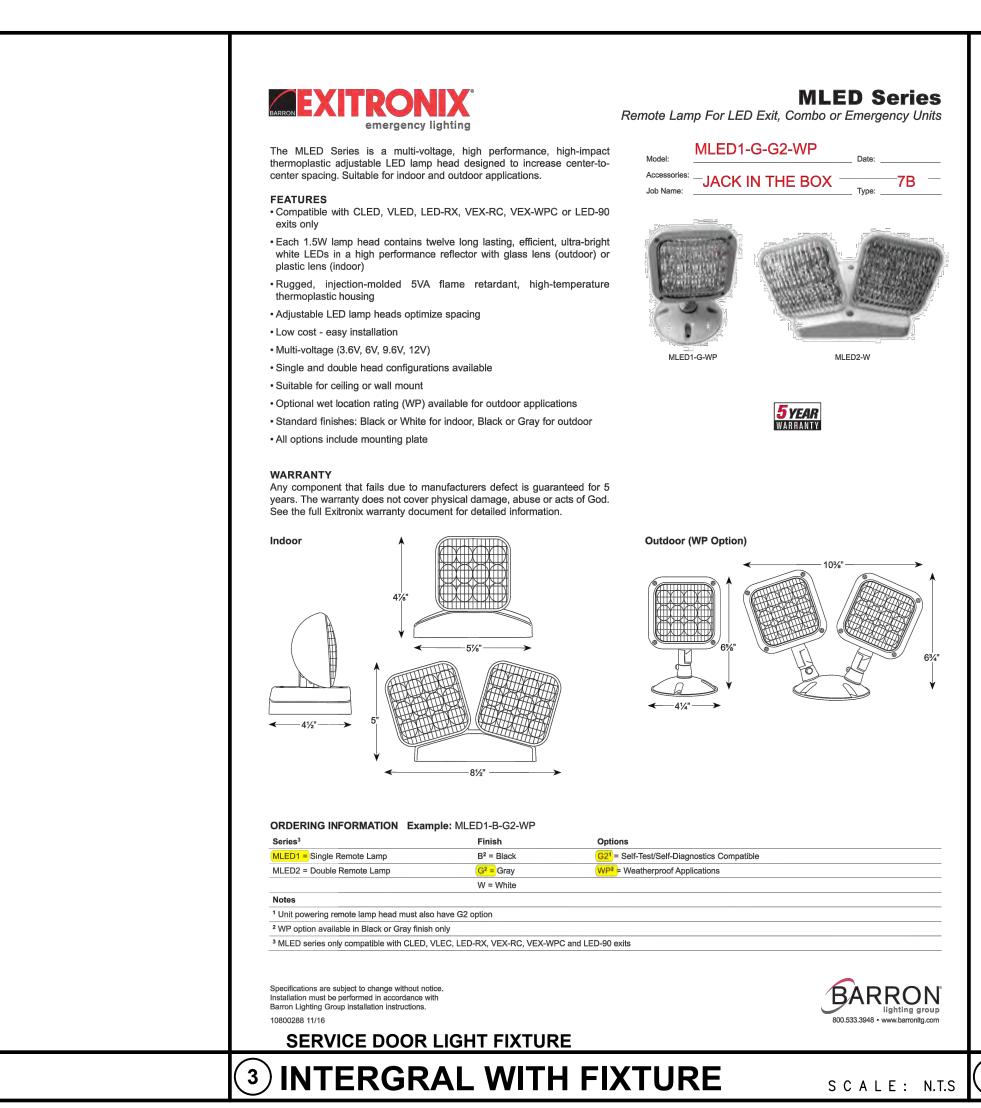

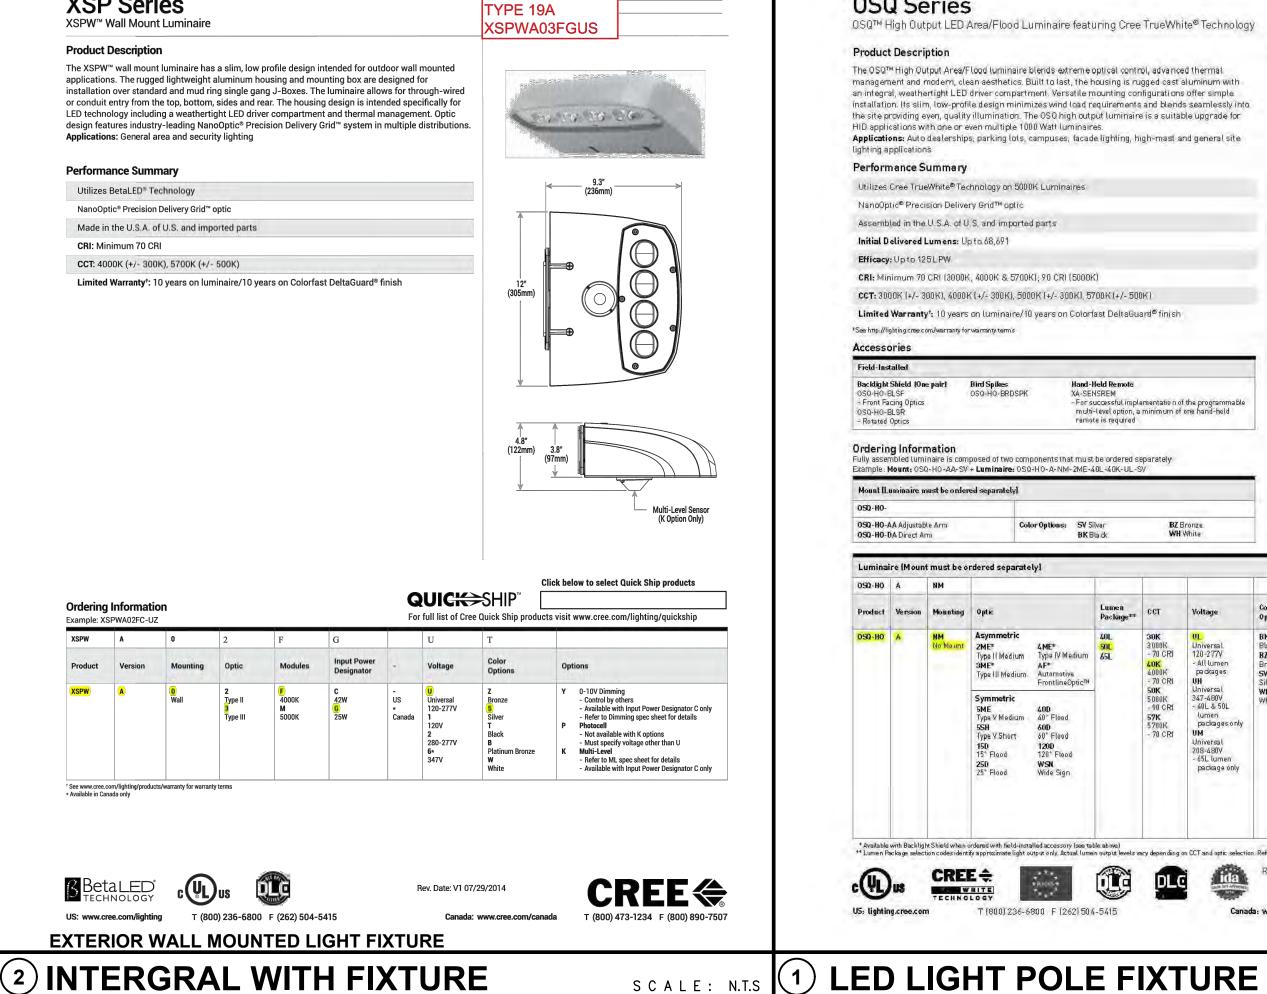

SCALE: N.T.S

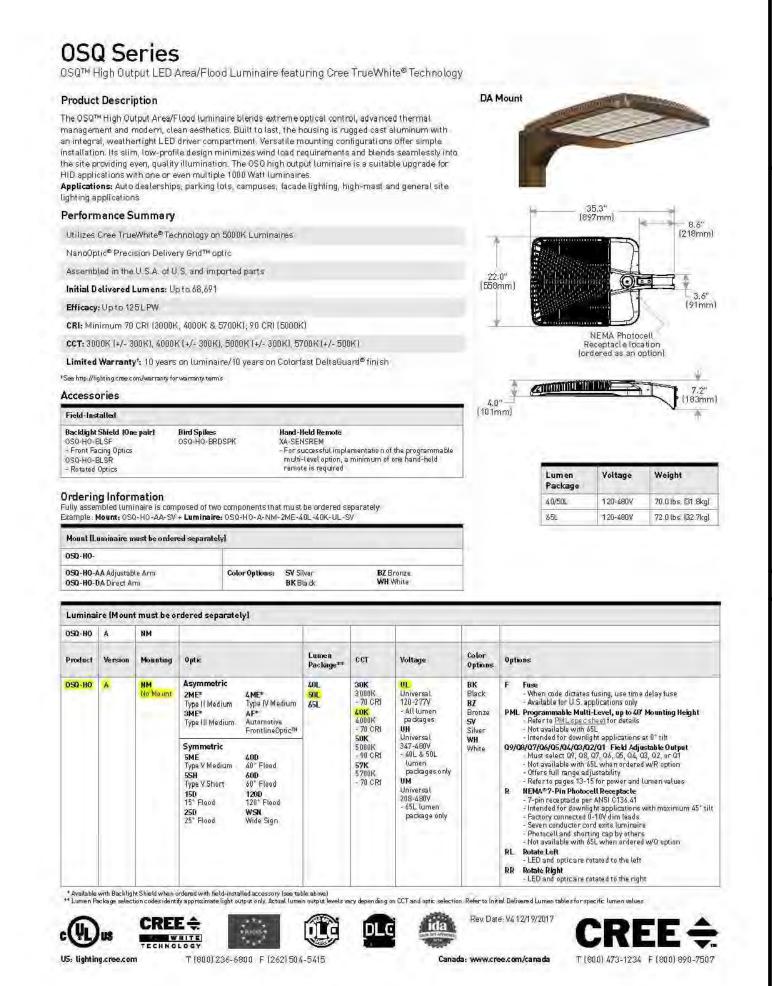

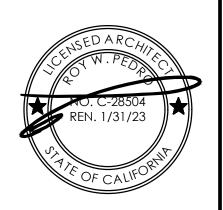



SITE INFORMATION MK TYPE: MK9DS\_MD 4387 ADDRESS: 1240 W. WOOD ST. WILLOWS, CA 95988 DRAWN BY:


Roy W. Pedro, Architect

LIGHTING **DETAILS** 

**PROJECT #**: WFM20001.0

AS NOTED

SCALE: N.T.S

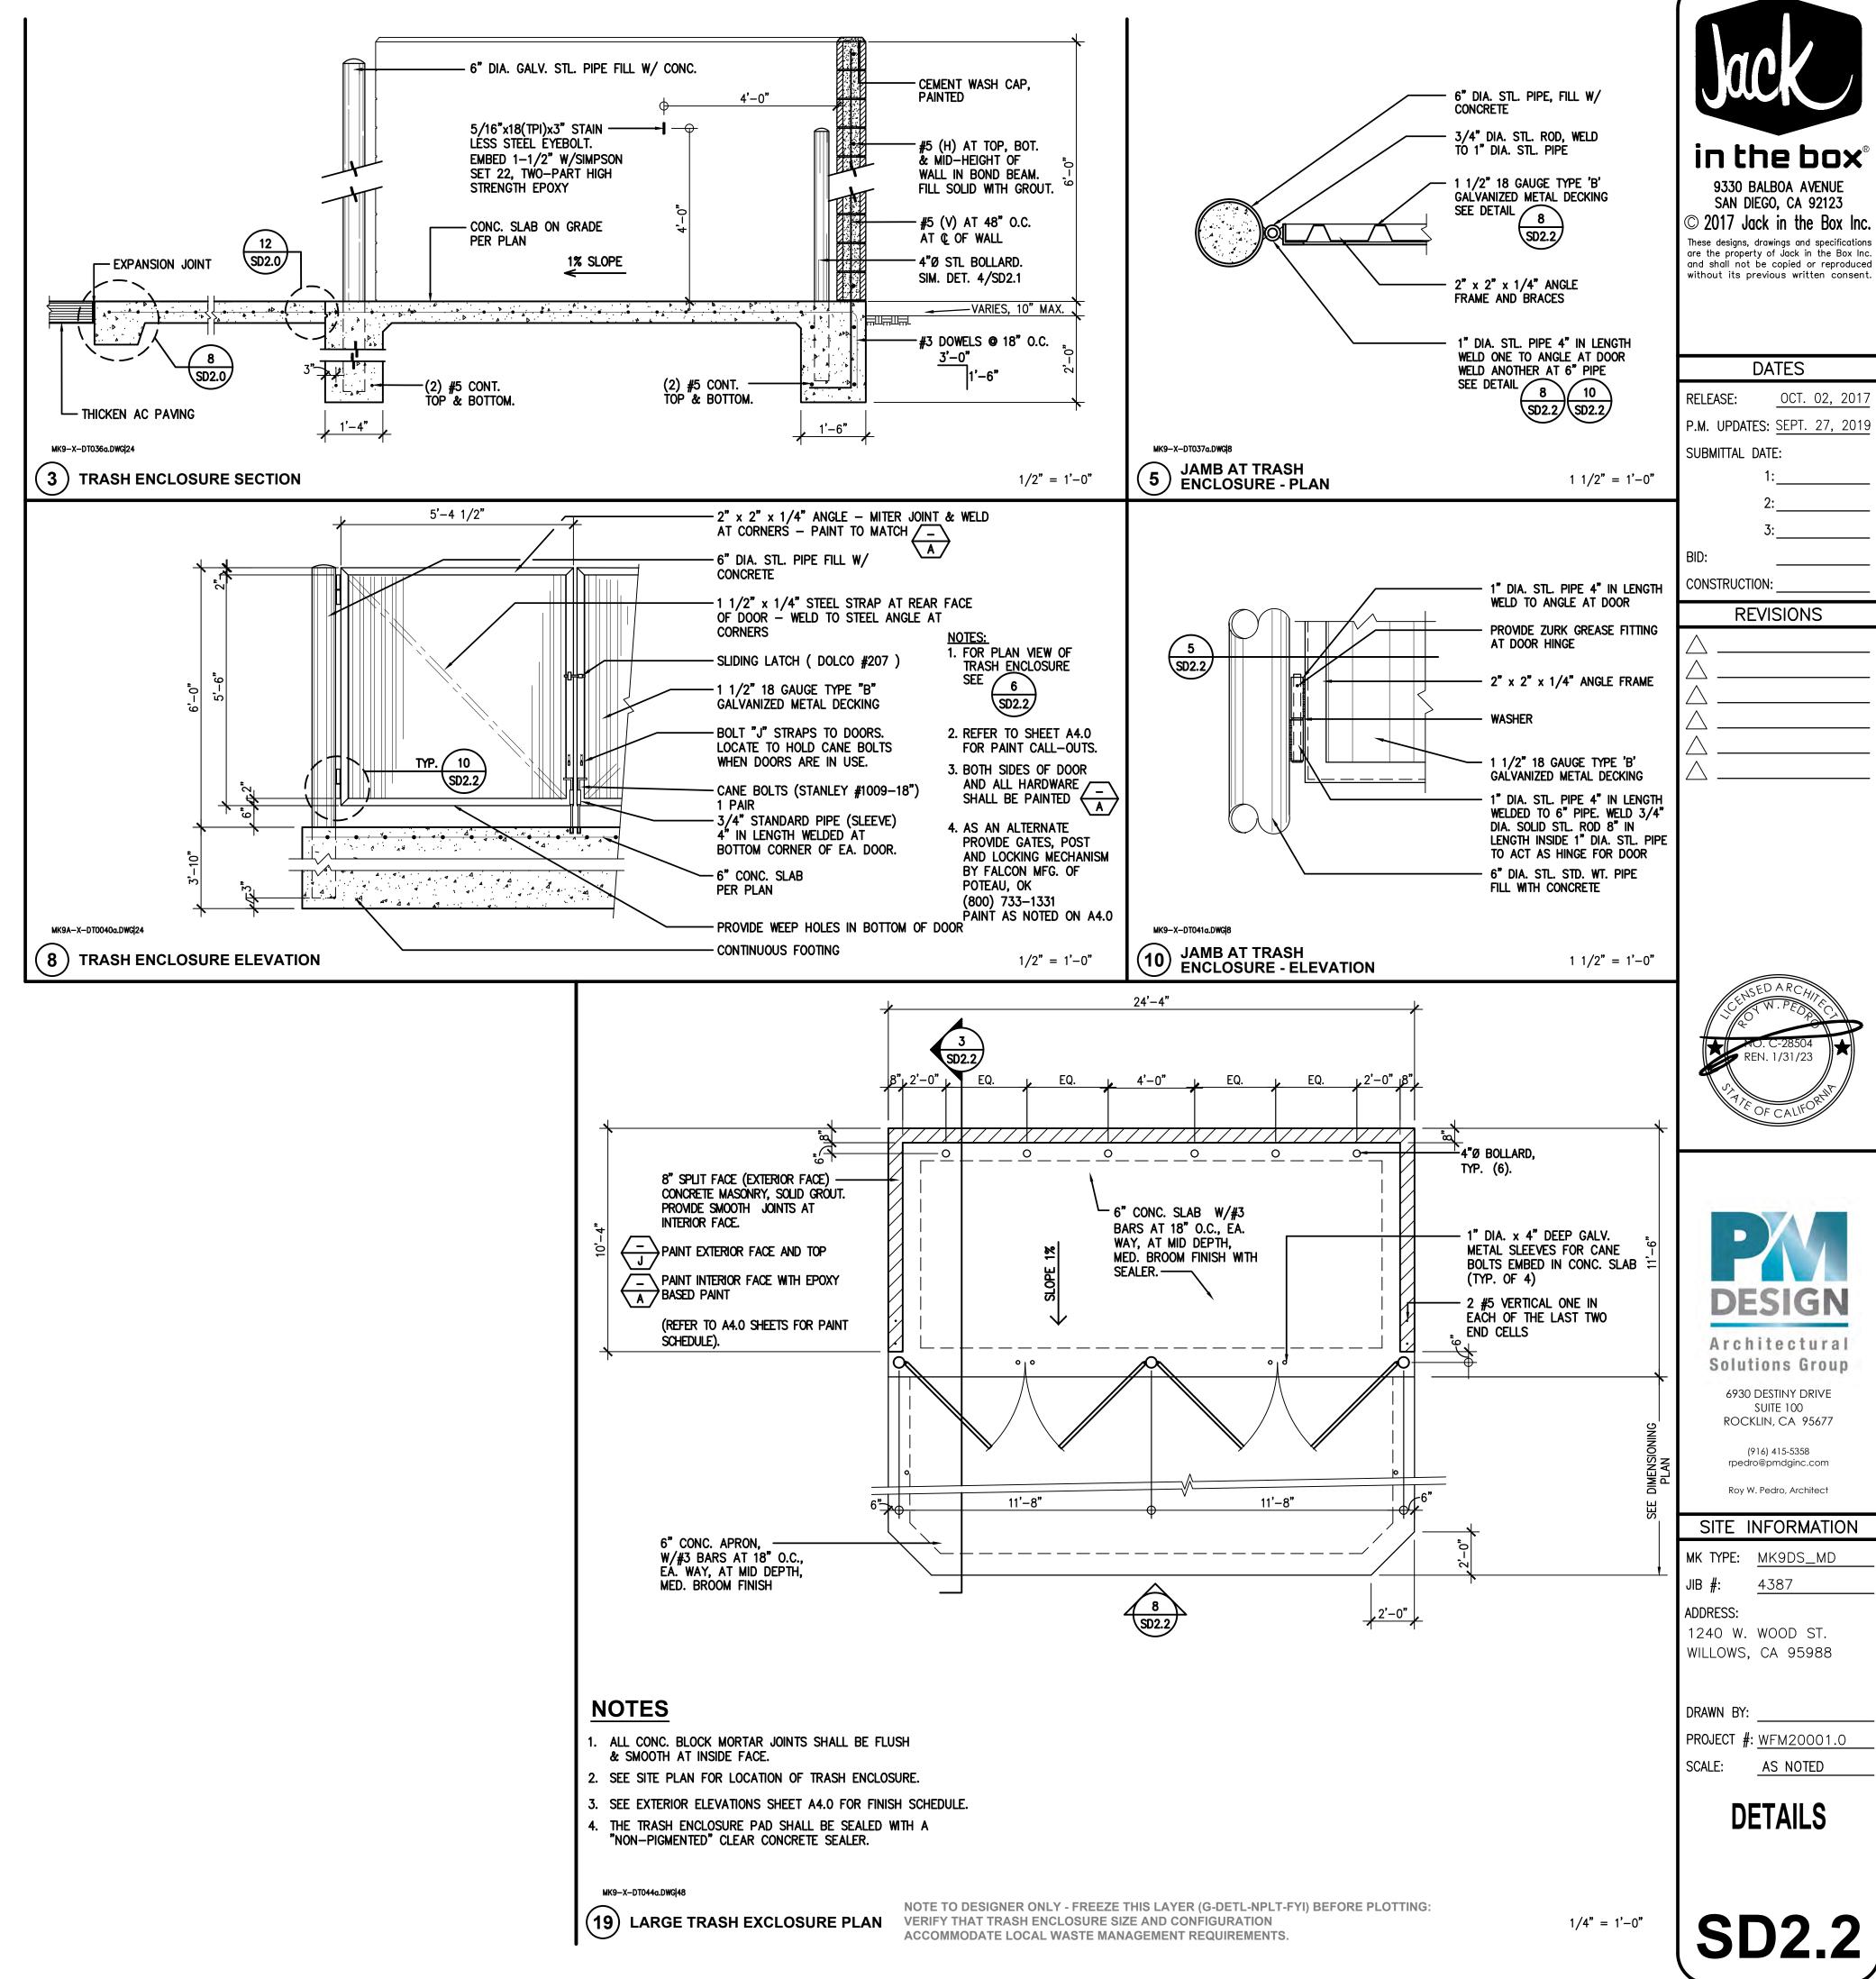



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DATES OCT. 02, 2017

SUBMITTAL DATE:

**REVISIONS** 



ROCKLIN, CA 95677 (916) 415-5358 rpedro@pmdginc.com

Roy W. Pedro, Architect

MK TYPE: MK9DS\_MD

1240 W. WOOD ST.

WILLOWS, CA 95988

PROJECT #: WFM20001.0

**DETAILS** 

### **GENERAL NOTES**

- 1. ALL DIMENSIONS SHOWN TO FACE OF EXTERIOR WALLS ARE FACE OF STUD, ALL DIMENSIONS SHOWN TO INTERIOR WALLS ARE TO CENTERLINE OF STUD, OR FACE OF FINISH GYPSUM BOARD OR PLYWOOD.
- 2. ALL EXTERIOR WALLS SHALL BE 2x6 WOOD STUDS AT 16" O.C. W/ 5/8" WATER RESISTANT GYPSUM BOARD ON THE INTERIOR FACE,
- 3. ALL INTERIOR WALLS SHALL BE 2x4 WOOD STUDS AT 24" O.C. W/ 5/8" WATER RESISTANT GYPSUM BOARD ON BOTH SIDES, U.O.N.
- A. (1) INDICATES INTERIOR WALL FACE W/ 5/8" PLYWOOD IN LIEU OF 5/8" WATER RESISTANT GYPSUM BOARD.
- (2) INDICATES INTERIOR WALL W/ 1/4" GYPSUM BOARD OVER 5/8" PLYWOOD.
- (3) INDICATES EXTERIOR WALL W/ 5/8" GYPSUM BOARD OVER 5/8" GYPSUM BOARD TO BE FLUSH WITH INTERIOR WALL.
- B. INDICATES INTERIOR WALLS THAT SHALL BE 2x6 WOOD STUDS AT 24" O.C.
- C. INDICATES WALLS THAT SHALL BE: INTERIOR: 20ga 5 1/2" STL. STUDS AT 24" O.C. USE NON-COMBUSTIBLE BLOCKING AT THIS LOCATION.
- D. TYPICAL INTERIOR WALLS, SEE DETAILS 18/A9.2 AND 19/A9.2.
- PROVIDE 2x SOLID BLOCKING IN WALLS AS REQUIRED FOR REINFORCEMENT OF ALL GRAB BARS, RESTROOM FIXTURES, PLUMBING LINES, WALL BUMPERS AND MILLWORK ATTACHMENT, ETC. SEE SHEET A7.0 FOR RESTROOMS AND SHEETS K2.0, K2.1, AND K2.2 FOR KITCHEN, EMPLOYEE AND WORKSTATION AREAS.

- 5. FOR EXTERIOR WALL TREATMENT, SEE EXTERIOR ELEVATIONS.
- ALL EXIT DOORS SHALL BE OPERABLE FROM THE INSIDE WITHOUT ANY SPECIAL KNOWLEDGE OR EFFORT OR THE USE OF A KEY.
- ALL EXTERIOR DOORS SHALL BE WEATHERSTRIPPED. ALL EXTERIOR JOINTS AROUND DOOR FRAMES & WINDOWS & AT ALL PENETRATIONS THROUGH BUILDING ENVELOPE SHALL BE SEALED USING SEALANT & CAULKING. ADDITIONALLY, FOAM INSULATION SHALL BE PROVIDED IN & AROUND ALL WINDOW AND/OR DOOR FRAMES WHERE METAL MEETS
- ALL GLAZING WITHIN DOORS AND OPERABLE WINDOW, AND ALL GLAZING ADJACENT TO DOORS SHALL BE TEMPERED AS REQUIRED BY CURRENT 16. BUILDING CODE.
- POST OCCUPANCY LOAD SIGN IN CONSPICUOUS PLACE NEAR MAIN EXITS AT 6'-10" A.F.F. CAULK AROUND ALL SIDES. "MAXIMUM SEATING CAPACITY - \_\_\_\_\_\_. FOR SEAT COUNT, SEE "BUILDING DATA" ON SHEET <u>TS1.0</u>.
- 10. ALL FINISH SURFACES SHALL HAVE A FLAME SPREAD CLASSIFICATION OF CLASS C OR HIGHER (FLAME SPREAD INDEX 76 THROUGH 200 & A SMOKE DENSITY RATING OF 450).
- 11. ALL DRAPES, CURTAINS & DECORATIVE MATERIAL PROVIDED AND/OR INSTALLED BY THE GENERAL CONTRACTOR SHALL BE MADE FROM NONFLAMMABLE MATERIALS OR TREATED WITH FLAME RETARDANT AS APPROVED BY THE LOCAL FIRE MARSHAL.

- 12. OWNER SHALL PROVIDE PORTABLE FIRE EXTINGUISHERS PER LOCAL FIRE MARSHAL. GENERAL CONTRACTOR TO INSTALL.
- 13. BUILDING ADDRESS NUMBERS SHALL BE A MINIMUM 12" HIGH AND BE OF CONTRASTING COLORS.
- ANY TIME THE BUILDING IS OCCUPIED, THE MEANS OF EGRESS SHALL BE ILLUMINATED AT AN INTENSITY OF NOT LESS THAN 1 FOOT-CANDLE AT THE FLOOR LEVEL. SEE ELECTRICAL DRAWINGS.
- WOOD FRAMING PLUS ALL EXTERIOR WALL OPENINGS/PENETRATIONS. 15. PROVIDE EXIT SIGNS FOR EGRESS IDENTIFICATION. SEE ELECTRICAL DRAWINGS.
  - PROVIDE APPROVED EGRESS ILLUMINATION AND ILLUMINATED EXIT SIGNS. SEE ELECTRICAL DRAWINGS.
- 17. PROVIDE APPROVED PANIC HARDWARE ON EXIT DOORS.
- 18. CONTRACTOR TO PROVIDE BORIC ACID TERMITE PROTECTION IN ALL WALLS.
- 19. GENERAL CONTRACTOR SHALL COORDINATE THEIR WORK WITH THE WORK OF THE FOOD SERVICE EQUIPMENT CONTRACTOR.
- 20. FOR ITEMS FURNISHED BY OTHERS & INSTALLED BY GENERAL CONTRACTOR SEE KITCHEN DRAWINGS.
- 21. CONSULT CONSTRUCTION MANAGER FOR REQUIREMENTS FOR AIR CURTAINS AT DRIVE THRU AND CASHIER WINDOWS AND AT DINING ENTRIES. PROVIDE DOOR SWITCHES AS NECESSARY.
- 22. EXIT AISLES SHALL MEET ALL APPLICABLE CODES.

# **KEY NOTES**

1 ) ROOF DRAINS PER 11/A9.3. SEE SITE PLAN FOR (14) GREASE TANK / BULK OIL SYSTEM, SEE KITCHEN CONTINUATION.

4 ) R-19 BATT INSULATION IN ALL EXT. WALLS AND SOUND

✓ INSULATION IN ALL RESTROOM AND WORKSTATION WALLS.

7 ) WALK-IN FREEZER AND COOLER, SEE KITCHEN DRAWINGS.

8 ) ELECTRICAL METER, SEE EXTERIOR ELEV. AND ELECTRICAL

( 2 ) GAS METER, SEE PLUMBING DRAWINGS.

5 ) BARRIER POST, TYP., SEE SITE DETAILS.

( 9 ) CO2 FILL BOX, SEE EXTERIOR ELEVATIONS.

10 ) ELECTRICAL PANELS, SEE ELECTRICAL DRAWINGS.

12) COUNTER AT DRIVE—THRU WINDOW. SEE GENERAL

NOTE 8 THIS SHEET AND DETAIL 13/A9.1.

11 ) GREASE TANK / BULK OIL SYSTEM BOX, SEE KITCHEN

(13) LADDER TO ROOF, SEE DETAILS <u>10/A9.0</u> AND <u>20/A9.0</u>.

6 ) LINE OF CONCRETE CURB, TYP.

DRAWINGS.


- (15) IRRIGATION CONTROLLER IN TAMPERPROOF ENCLOSURE, SEE LANDSCAPE AND ELECTRICAL DRAWINGS.
- 3 LINE OF FOOD SERVICE EQUIPMENT, SEE KITCHEN DRAWINGS. (16) MOP SINK, SEE DETAIL 16/A9.2.
  - 17 ) ROOF OVERHANG ABOVE.

DRAWINGS.

- ( 18 ) LINE OF CANOPY, TYP.
- ( 19 ) PROVIDE NON-COMBUSTIBLE BLOCKING IN WALL FOR KITCHEN EQUIPMENT. SEE GENERAL NOTE 4 THIS SHEET FOR ADDITIONAL
- (20) PARTIAL HEIGHT INTERIOR WOOD STUD WALL. SEE INTERIOR DRAWINGS AND DETAIL 20/ID3.1 FOR ADDITIONAL INFORMATION.
- (21) 6" BLOCK OUT AT THIS LOCATION FOR LIGHTING TIME CLOCK, SEE ELECTRICAL DRAWINGS.
- (22) END CAP ON WALL TO BE FLUSH W/ SOFFIT FINISH ABOVE. SEE INTERIOR DETAILS FOR ADDITIONAL INFORMATION.
- (23) INSTALL 5/8" GYPSUM BOARD OVER STEEL STUDS. DO NOT INSTALL F.R.P. BEHIND HOODS. SEE KITCHEN DRAWINGS FOR
- (24) LANDING BEGINNING ELEV. 0'-0" TO SLOPE MAX 2% AWAY FROM BUILDING.
- (25) AREA OF ADDITIONAL FURRING.

STAINLESS STEEL FINISH.

- (26) TRELLIS PIER BASE WITH COLUMN. SEE STRUCTURAL DRAWINGS.

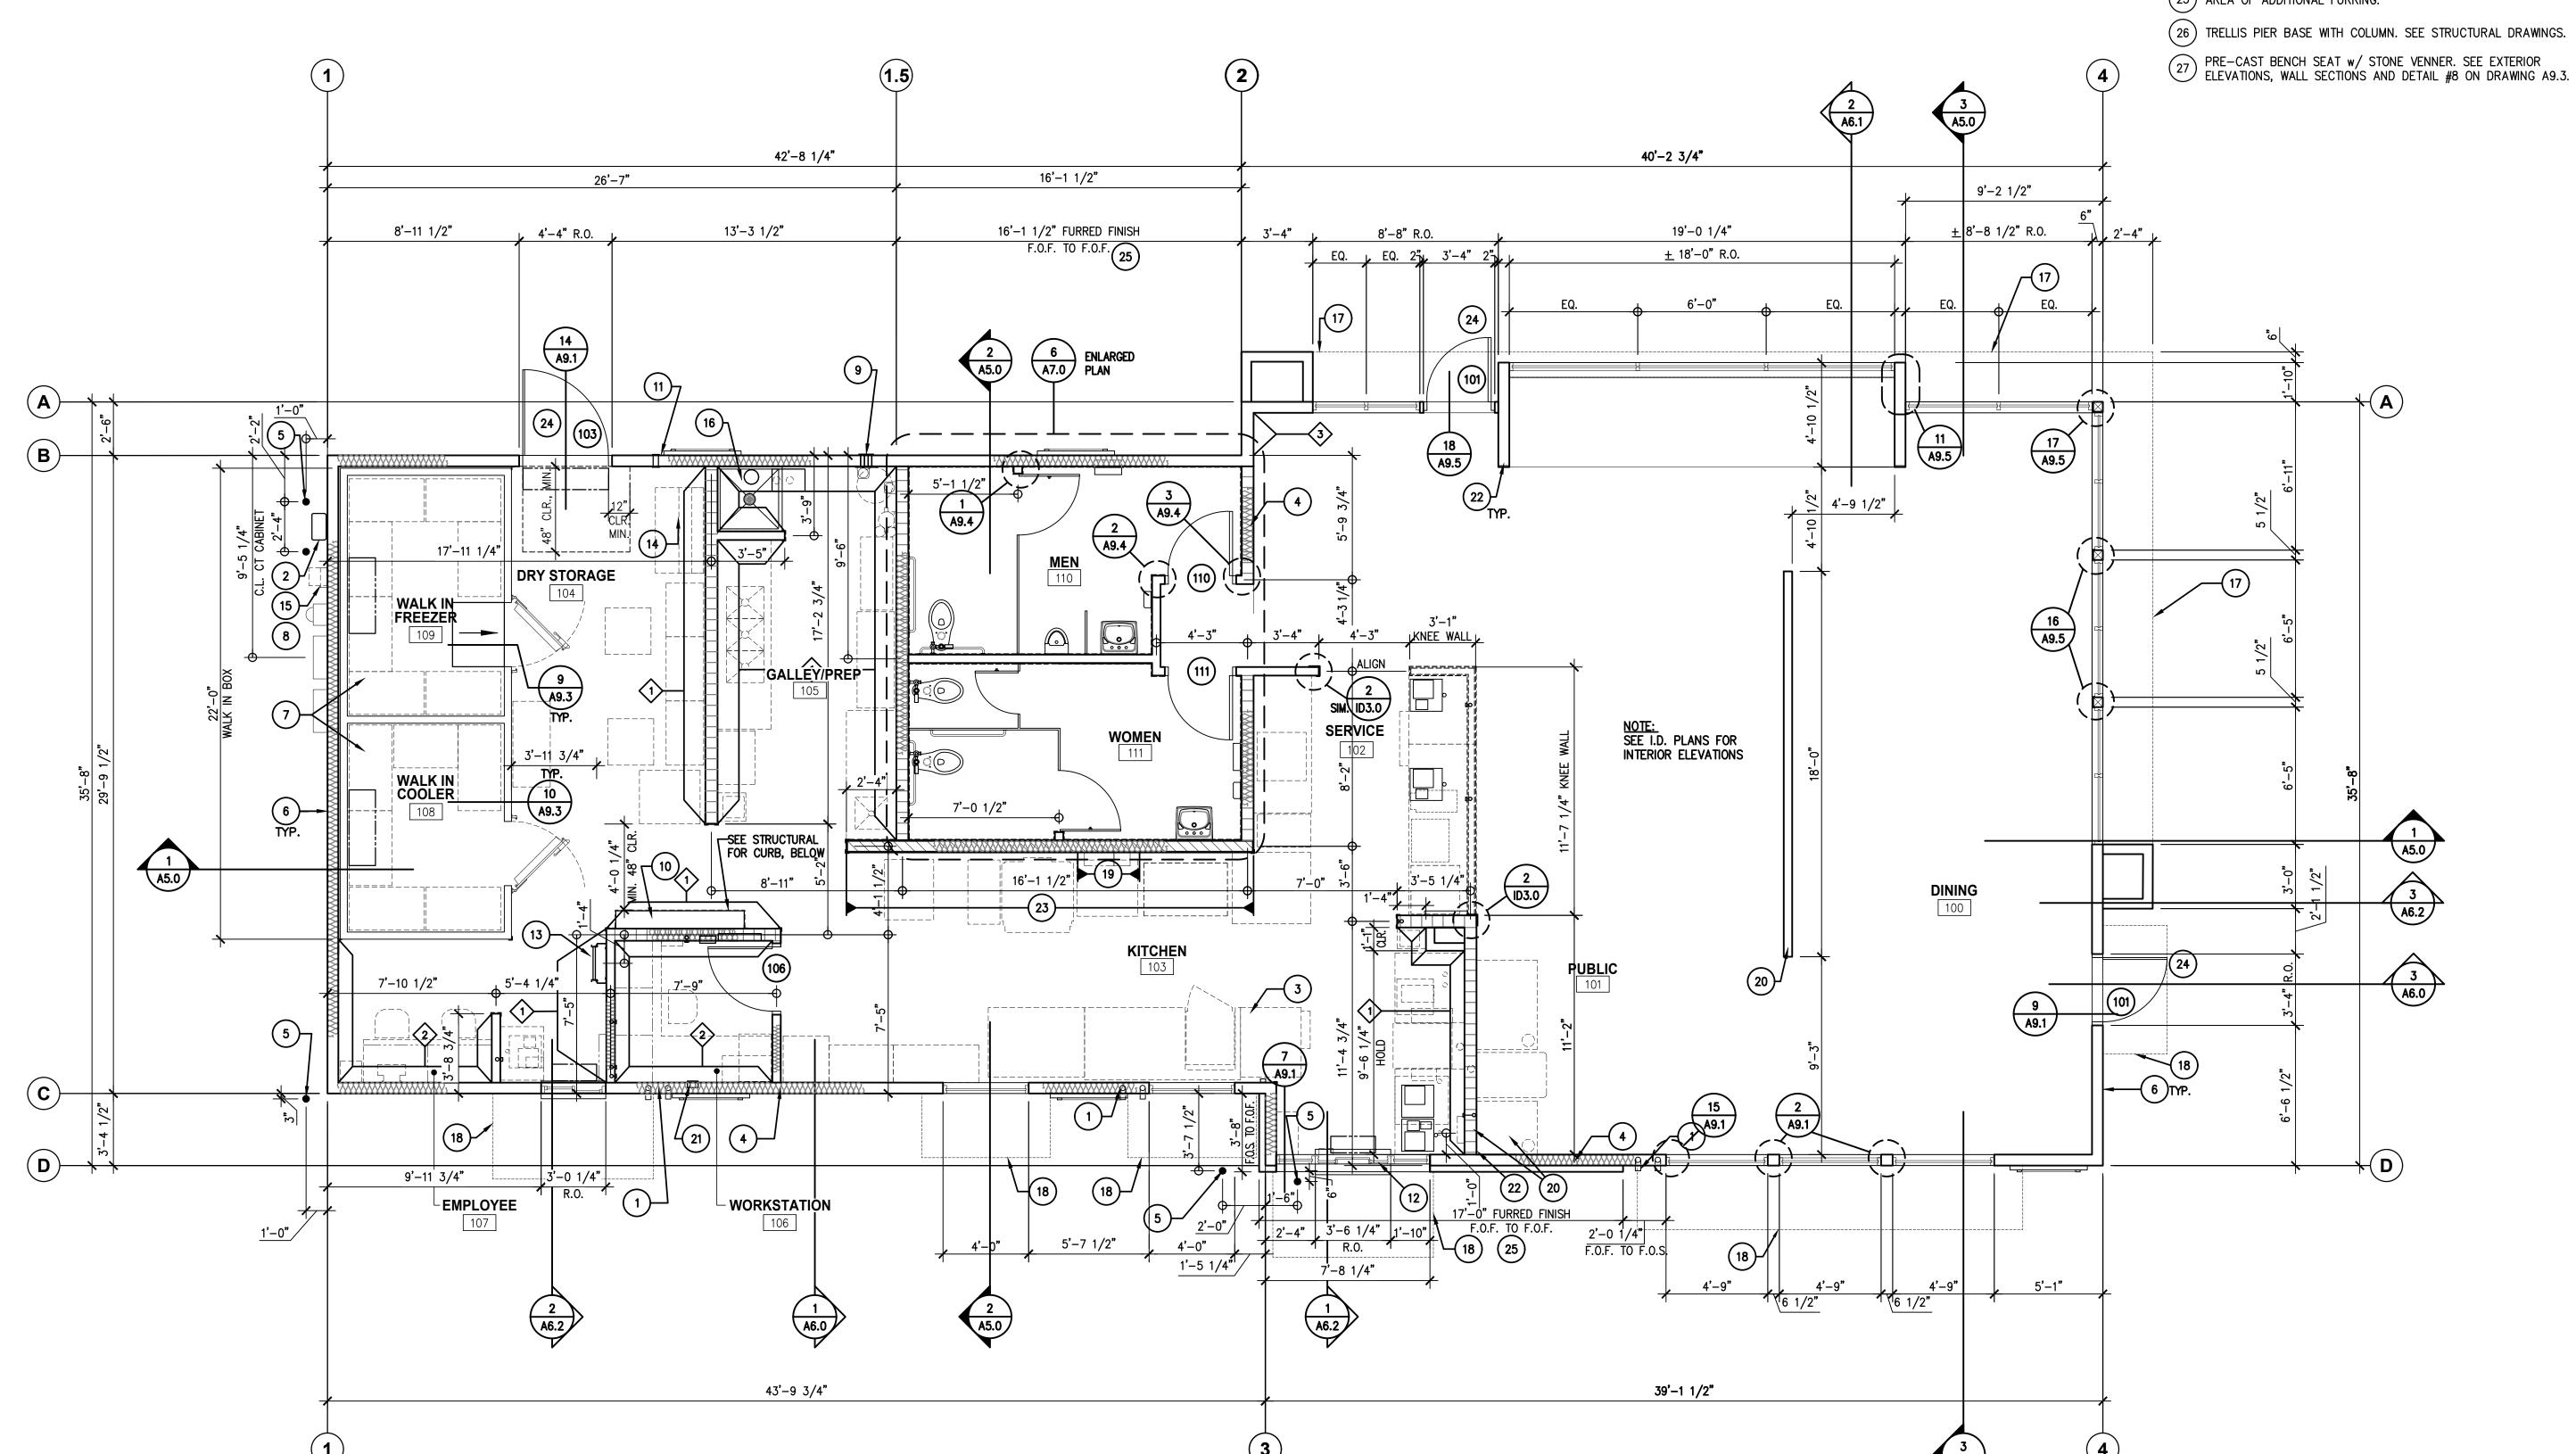



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SITE INFORMATION MK TYPE: MK9DS\_MD JIB #: 4387

(916) 415-5358 rpedro@pmdginc.com

Roy W. Pedro, Architect

1240 W. WOOD ST. WILLOWS, CA 95988

DRAWN BY:

PROJECT #: WFM20001.0 SCALE: 1/4" = 1'-0"

**FLOOR PLAN** 

# **KEY NOTES**

- CRICKET, TYP. SEE DETAIL <u>8/A9.0.</u>
- 2) 32"X32" TILED ROOF WALKWAY, SEE SPECIFICATIONS.
- 3 CANOPY BELOW
- ROOF AND OVERFLOW DRAINS AT ROOF, SEE PLUMBING DRAWINGS AND DETAILS 1/A9.3 AND 6/A9.3.
- 5 ROOF DRAIN OVERFLOW LEADERS DOWN IN WALL, SEE DETAIL 11/A9.3.
- 6 1 HR. FIRE RATED DUCT WRAP AT HOOD, SEE SPECIFICATIONS.
- (7A) DRIVE—THRU ICE MAKER CONDENSER ON ROOF EQUIPMENT PLATFORM

BY G.C. FOR ROOF PENETRATION, SEE DETAIL 17/A9.0.


7B SELF-SERVE ICE MAKER CONDENSER ON ROOF EQUIPMENT PLATFORM BY G.C. FOR ROOF PENETRATION, SEE DETAIL 17/A9.0.

- 9 GREASE EXHAUST FAN UNIT
- HOSE BIBB AT +18" ABOVE ROOF LEVEL, SEE PLUMBING DRAWINGS.
- 11) HOOD BELOW
- 12) PLUMBING VENT, SEE DETAIL 12/A9.0.
- (13) LINE OF W.I.B. BELOW
- (14) ROOF ACCESS, SEE DETAIL <u>20/A9.0.</u>
- freezer refrigeration unit
- (15B) COOLER REFRIGERATION UNIT

- PROVIDE "FIRE BLOCK" AT 20'-0" O.C. MAX. WITH 5/8" TYPE 'X' GYP. BD. ON 2x4 STUDS AT 24" O.C., ALL JOINTS TAPED.
- (18) WALL BELOW
- 19 CRICKET AT EQUIPMENT BASES, SEE SIMILAR DETAIL
- (20) CANT STRIP, TYP.
- (21) HVAC UNIT, SEE MECHANICAL DRAWINGS.
- CLASS 'A' PVC ROOFING MEMBRANE, SEE SPECIFICATIONS.
- (23) CORRUGATED WALL PANELS O.F.O.I.

# **GENERAL NOTES**

- 1. FOR ROOF FRAMING AND PLYWOOD LAYOUT INFORMATION, SEE STRUCTURAL
- 2. FOR MECHANICAL EQUIPMENT AND INSTALLATION, SEE MECHANICAL DRAWINGS AND SPECIFICATIONS.
- 3. CURBS AND BASES FOR HVAC UNITS AND EXHAUST FANS SHALL BE INSTALLED LEVEL BY G.C. HVAC UNITS AND EXHAUST FANS SHALL BE HOISTED, SET IN PLACE, AND SECURED TO ROOF CURBS OR BASES BY G.C. AND PER MANUFACTURER'S INSTRUCTIONS.
- 4. WALK IN BOX ROOF TOP UNIT SHALL BY HOISTED, SET IN PLACE AND SECURED TO ROOF CURB BY G.C. ROOF CURB AND EQUIPMENT PLATFORM BY G.C.
- 5. ICE MACHINE ROOF TOP UNITS SHALL BE HOISTED, SET IN PLACE AND SECURED TO ROOF CURB BY ICE MACHINE INSTALLER. ROOF CURB AND EQUIPMENT PLATFORM BY G.C.
- 6. AS ALTERNATE, CONTRACTOR TO SUBSTITUTE BUILT-UP ROOFING IN LIEU OF PVC ROOFING. DETAILS ON SHEET A9.4 AND SPECIFICATIONS.

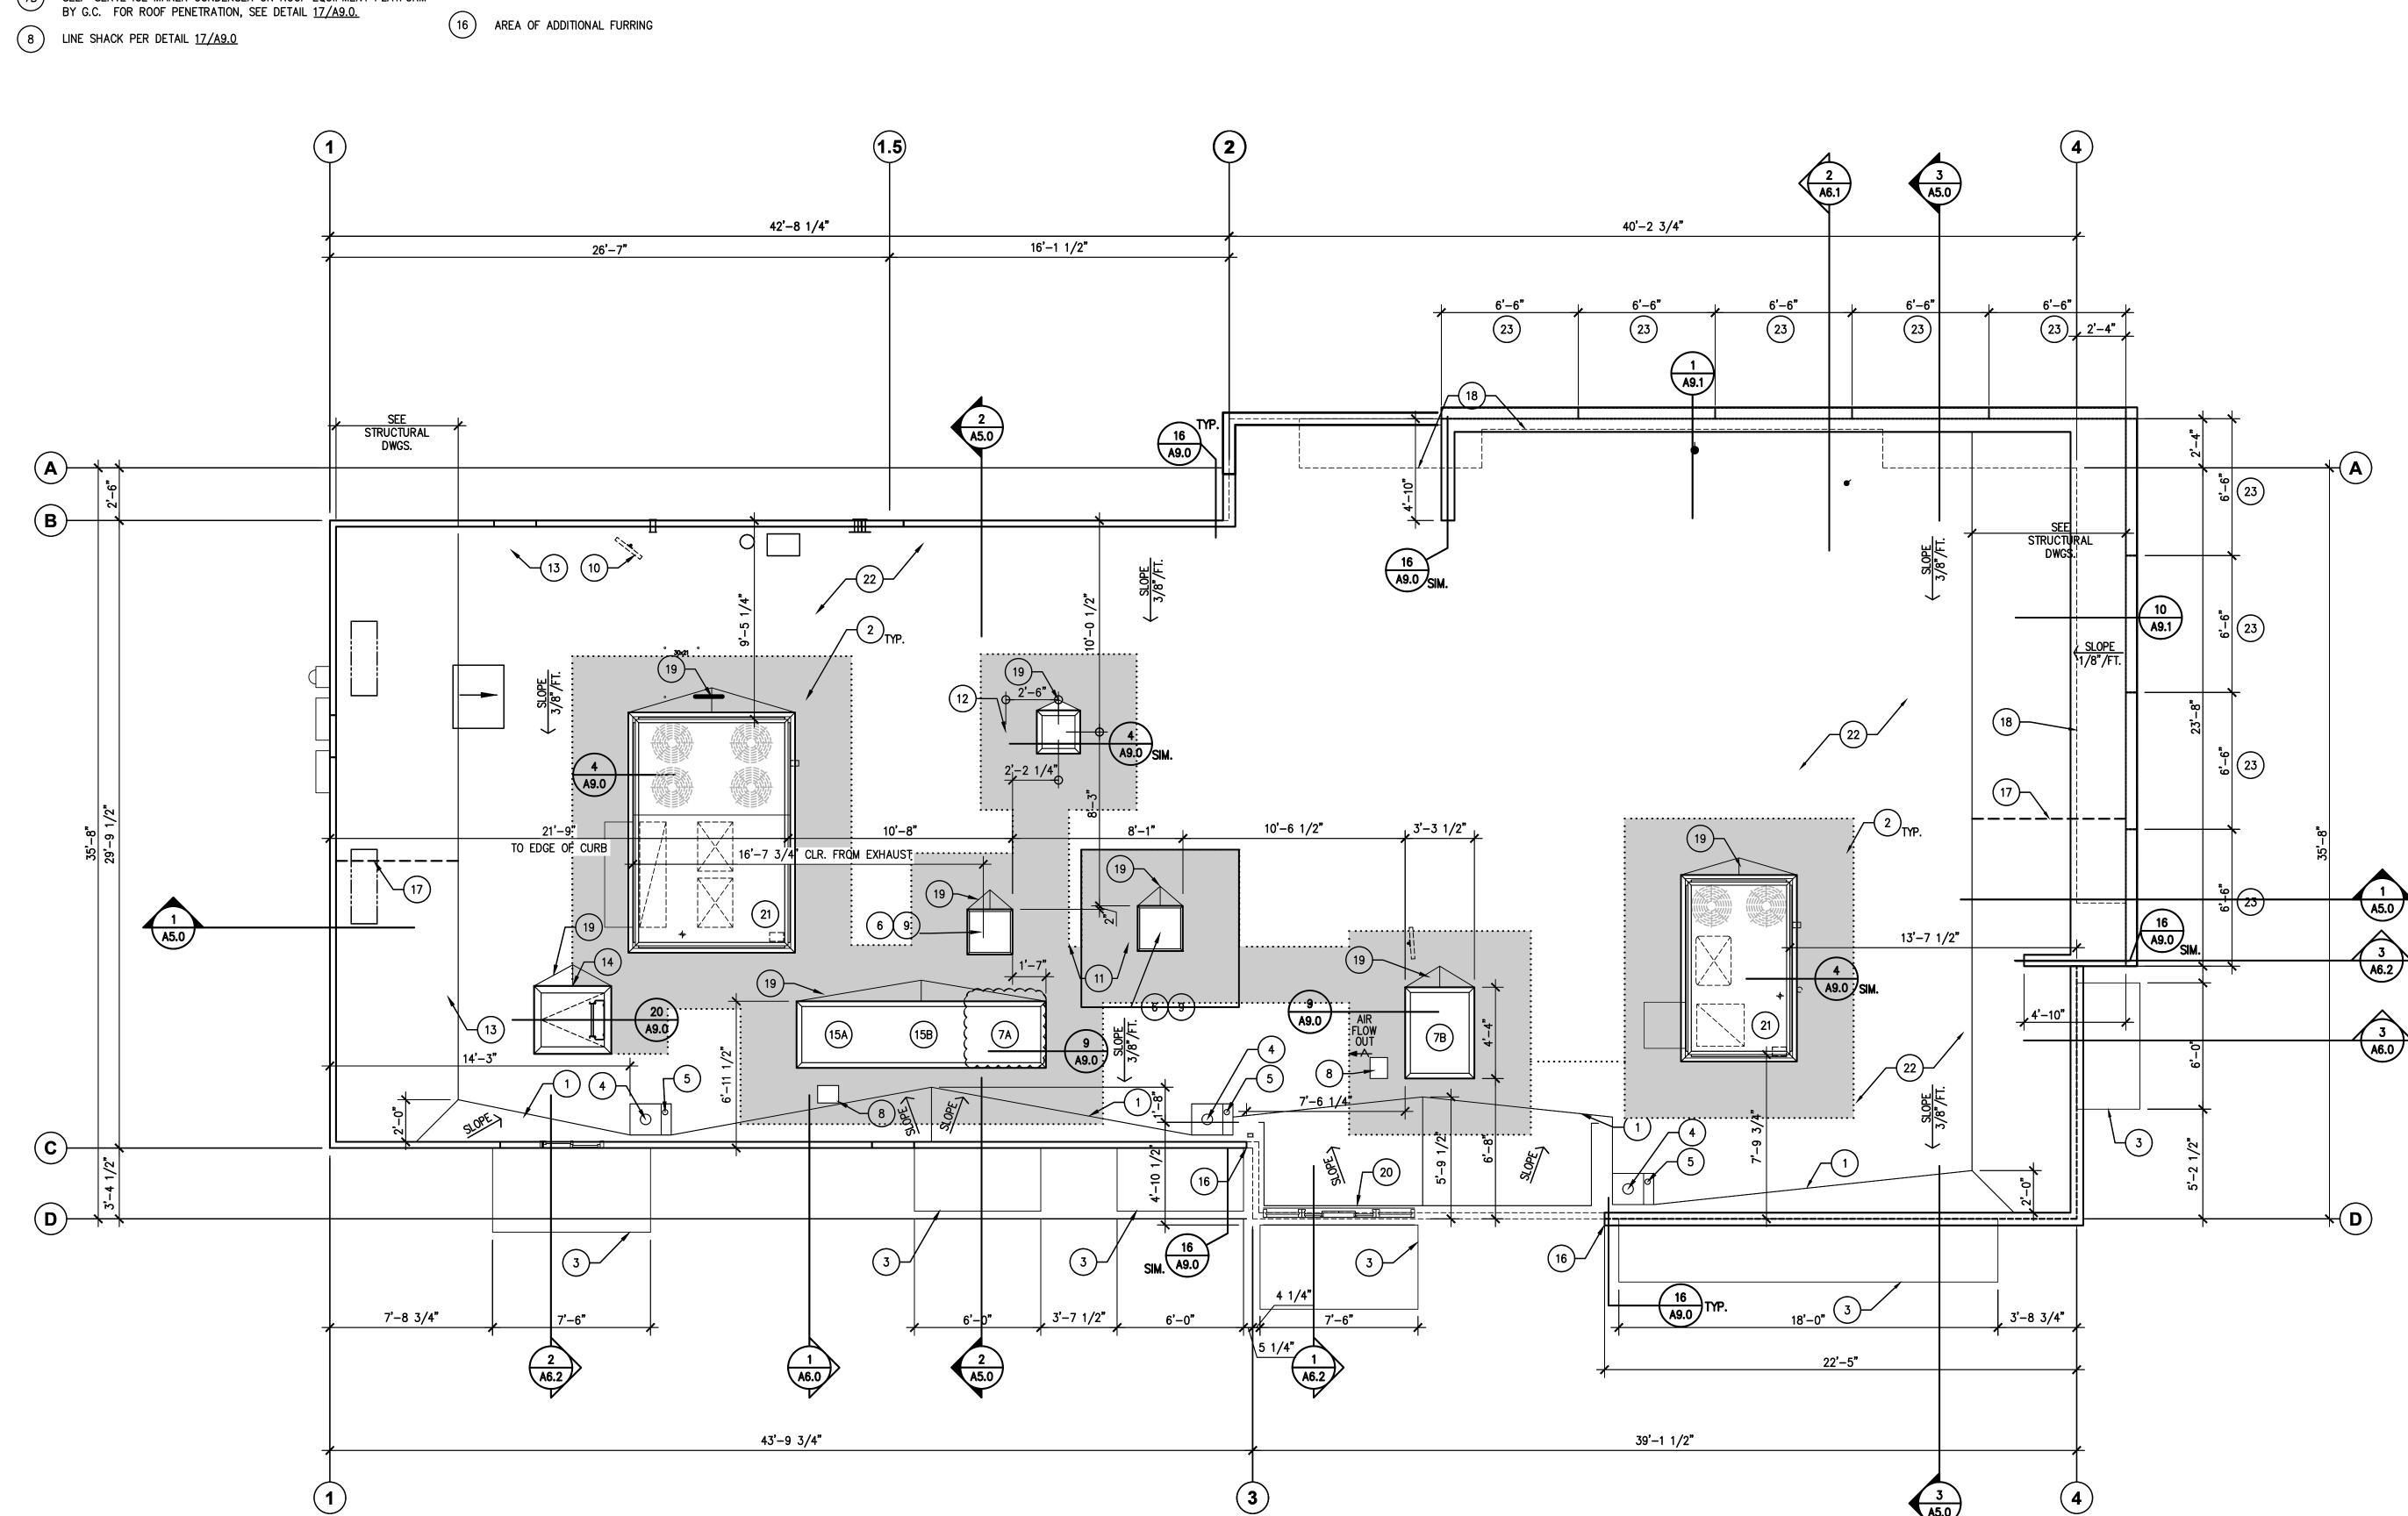




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SITE INFORMATION

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JIB #: 4387

Roy W. Pedro, Architect


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DRAWN BY: \_\_\_\_\_\_PROJECT #: WFM20001.0

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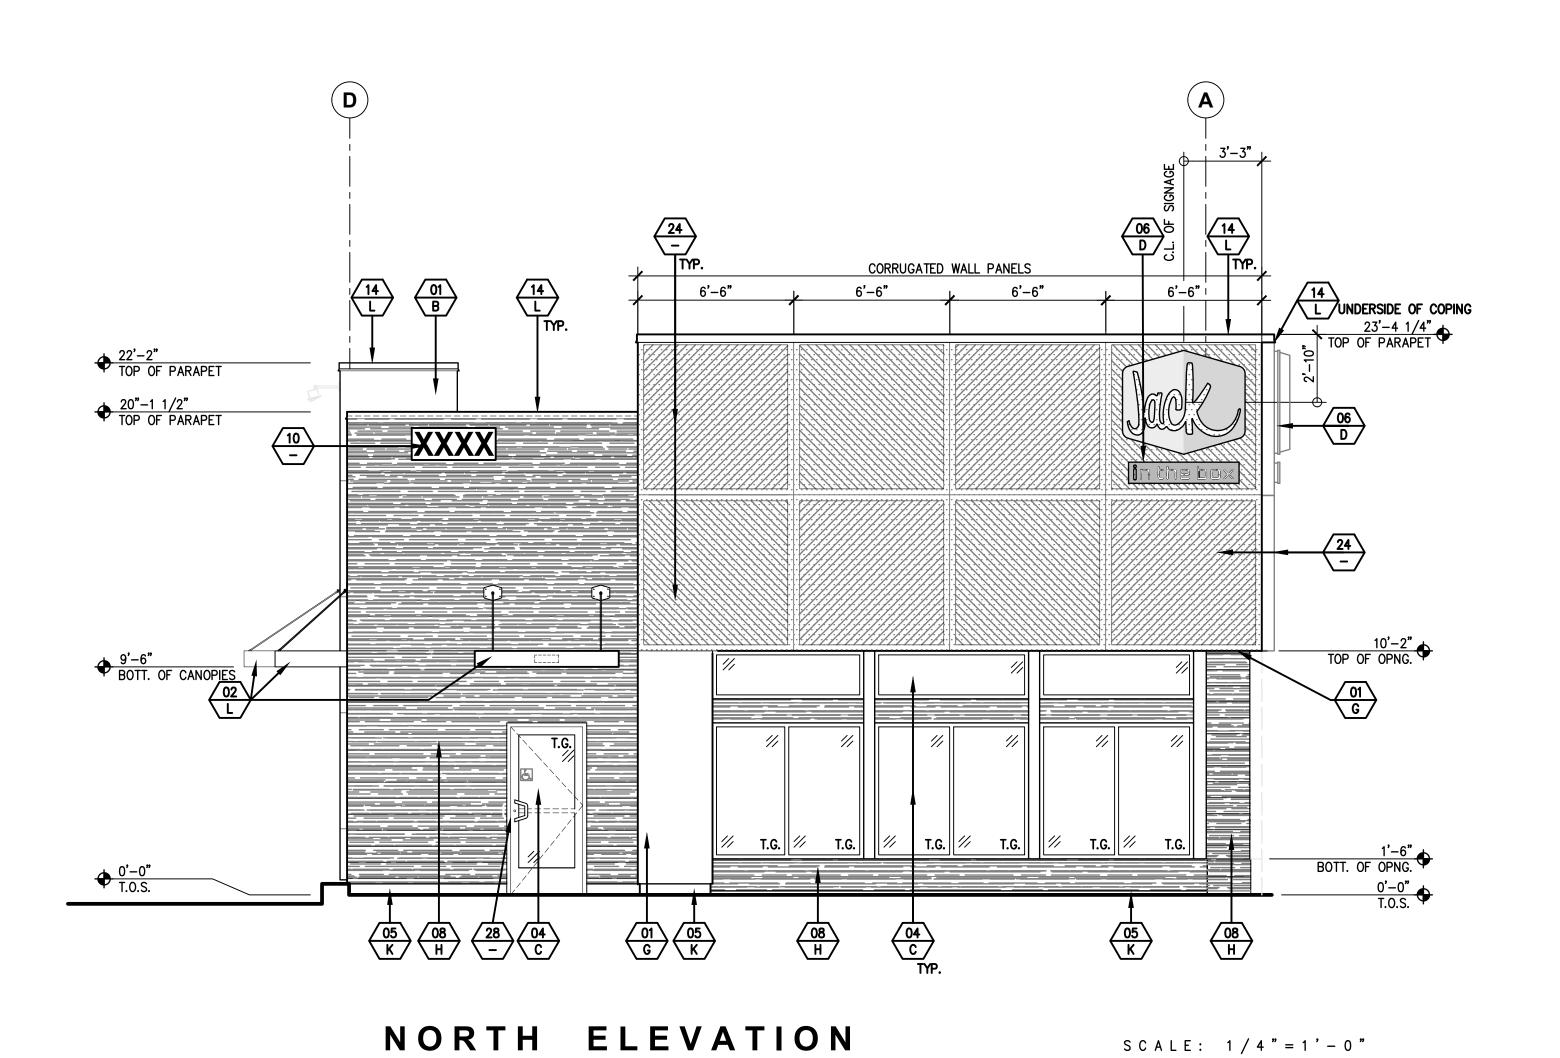
ROOF PLAN

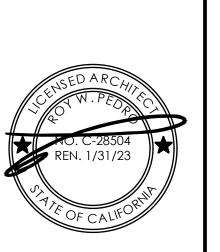**A3.0** 



EAST ELEVATION

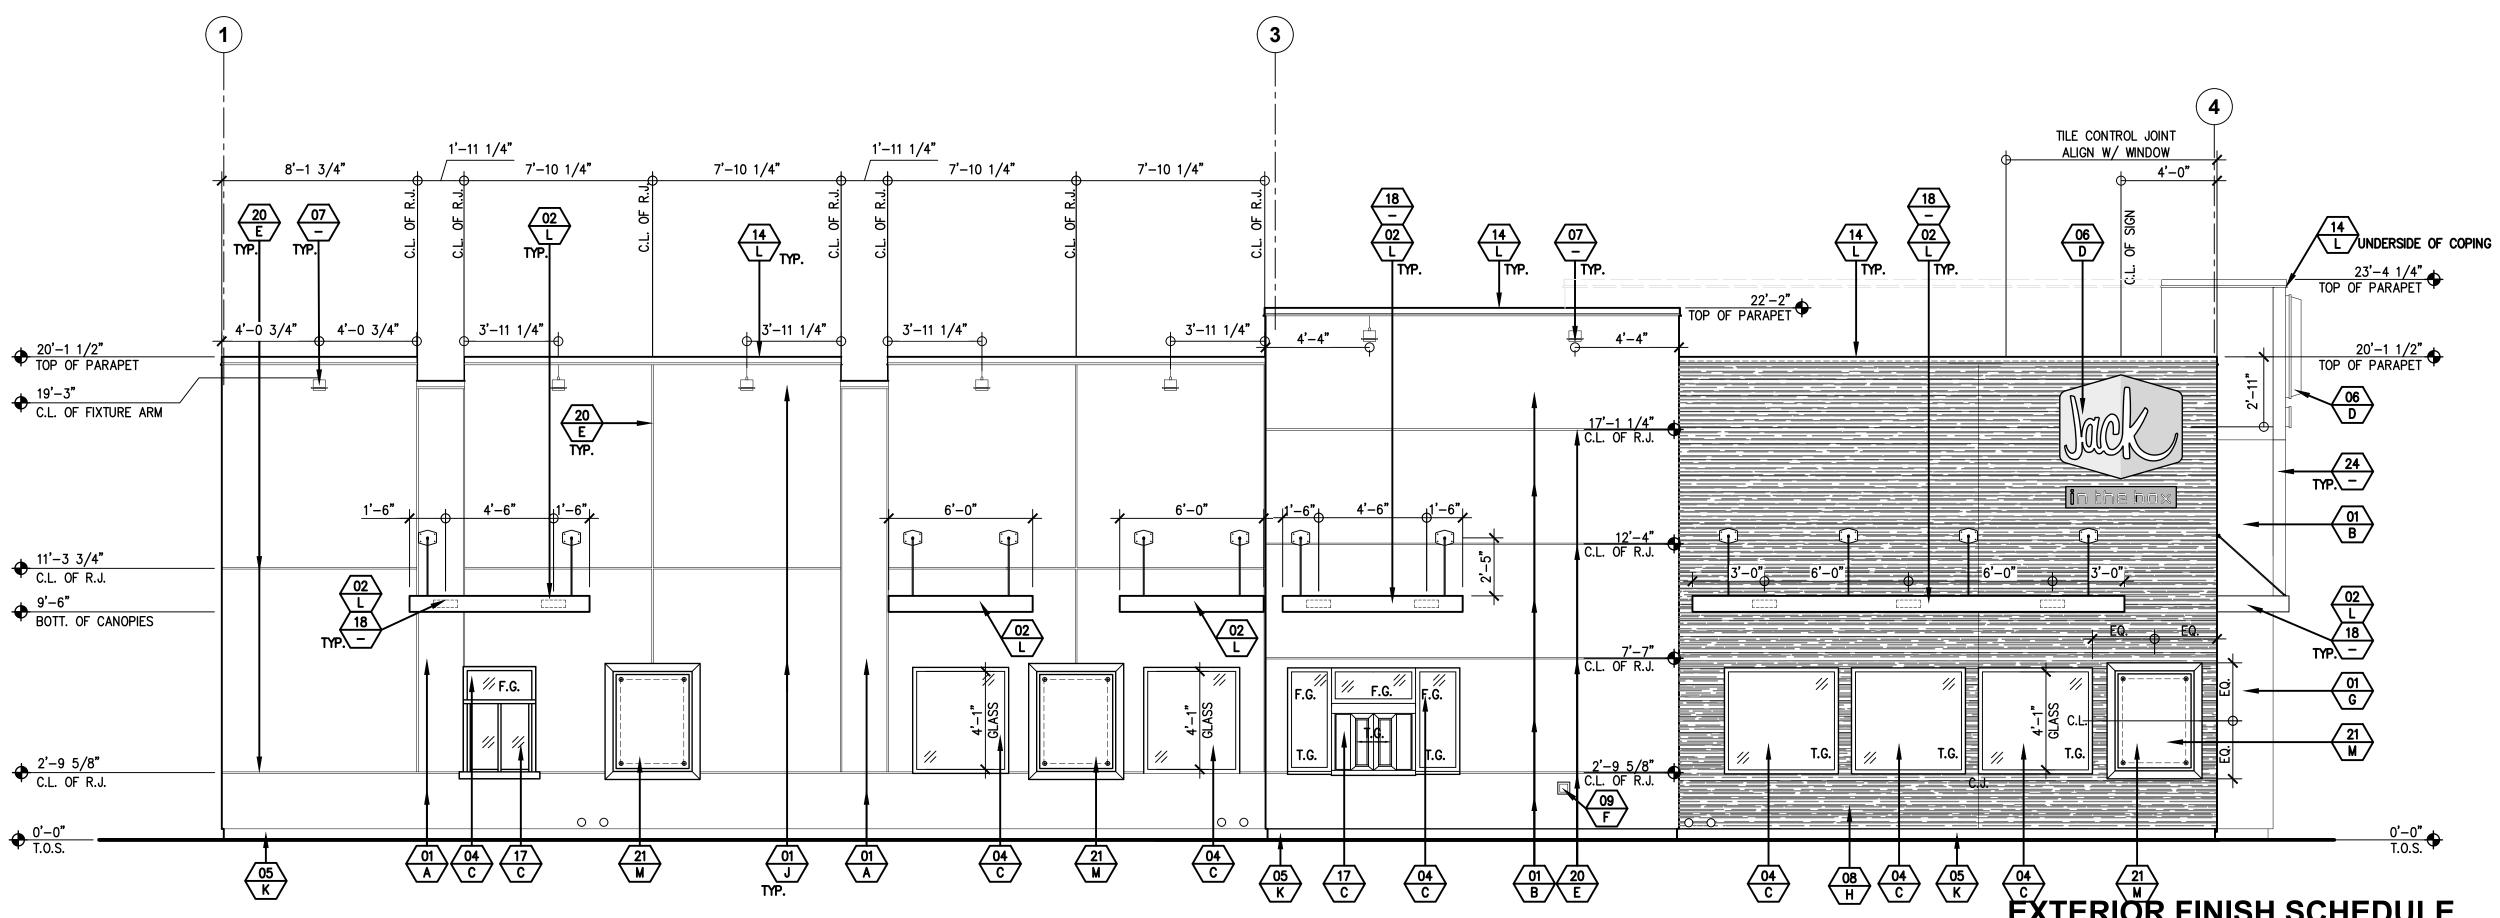
S C A L E: 1 / 4 " = 1 ' - 0 "



6'-0"	3'-0"
	EQ. 6 EQ. 18
	TYP.\
.1-1"	
S.   //	T.G. 21 M
C J.	
	0'-0" T.O.S. ◆
$\begin{array}{c c} \hline \\ 05 \\ \hline K \end{array} \qquad \begin{array}{c} 04 \\ \hline C \end{array}$	\(\frac{1}{21}\)
EX	TERIOR FINISH SCHEDULE USE CHECKED BOX ONLY
$\frac{\overline{01}}{A}$	MATERIAL/FINISH —— COLOR
MATEI	RIAL/FINISH:
01	EXTERIOR CEMENT PLASTER— SAND FLOAT FINISH (SEE SPECIFICATIONS)  INTEGRAL COLOR
	SHERWIN WILLIAMS ACRYLIC COATING
	EXTERIOR INSULATION FINISHING SYSTEM (EIFS) AS ALTERNATE, CONTRACTOR TO SUBSTITUTE EIFS IN LIEU OF EXTERIOR CEMENT PLASTER
02 03	AWNING/CANOPY & SUPPORTS (0.F.O.I) OF-EQ23 OF-EQ24  GREASE TANK / BULK OIL SYSTEM BOX  ALLIANUM ASTOREFOON TO SYSTEM (SEE SPECS FOR MORE INFORMATION)
04	ALUMINUM STOREFRONT SYSTEM (SEE SPECS FOR MORE INFORMATION)  1" CLEAR INSULATED GLASS  1" CLEAR INSULATED GLASS  W/ SOLARBAN ZOYL COATING
	1" CLEAR INSULATED GLASS  W/ SOLARBAN 70XL COATING  ANTI-GRAFFITI FILM
05 06	EXTERIOR CEMENT PLASTER FINISH COAT OVER CONCRETE CURB
06 07	INTERNALLY ILLUMINATED SIGNAGE (O.F.O.I., NOT A PART OF THIS PERMIT) WALL MOUNTED LIGHT FIXTURE, SEE DETAIL <u>16/A9.3</u> FOR FIXTURE ATTACHMENT. 8" PORCELAIN WALL TILE
08 09	RECESSED, LOCKABLE, NON-FREEZE HOSE-BIB ENCLOSURE
10 11	ILLUMINATED ADDRESS WITH 12" HIGH LETTERS (AS REQUIRED PER LOCAL JURISDICTION) (OF-EQ8)  MAIN ELECTRICAL SERVICE  LOCKABLE IRRIGATION CONTROL BANEL
12 13	LOCKABLE, IRRIGATION CONTROL PANEL HOLLOW METAL DOORS AND FRAMES, MISCELLANEOUS TRIM
14 15	ALUMINUM COPING CO2 FILL BOX METAL COVER DRIVE TURL ( CASHER WINDOW)
17 18	DRIVE THRU/ CASHIER WINDOW  MOUNT LIGHTING FIXTURE WITHIN CANOPY  FEATURE WINDOW DOD, OUT W/ ALLIMINUM PREAK METAL DANIELS
19 20	FEATURE WINDOW POP OUT W/ ALUMINUM BREAK METAL PANELS 3/4" ALUMINUM PLASTER REVEAL
21 22	DISPLAY POSTER PANEL & SURROUND, SEE DETAIL <u>2/A9.3</u> , <u>3/A9.3</u> , <code>@F-EQ18</code> &@F-EQ19 EXTERIOR WALL PACK LIGHT FIXTURE
23 24	NOT USED CORRUGATED WALL PANELS (O.F.O.I) < (OF-EQ10)
25 26	FIBER CEMENT SIDING PANEL SMOOTH FINISH CONCRETE BASE
27 28	STEEL POST W/ CUSTOM LIGHT FIXTURE AND BANNER DOOR PULL, SEE DOOR SCHEDULE OF-EQ13)
COLO	
A	SHERWIN WILLIAMS: SW 7020 "BLACK FOX"
B C	SHERWIN WILLIAMS: SW 6321 "REDBAY" STANDARD STOREFRONT: CLEAR ANODIZED
D E	WHITE TEXT ON RED BACKGROUND CLEAR ANODIZED
F G	COLOR/FINISH TO MATCH ADJACENT SURFACE SHERWIN WILLIAMS: SW 7020 "BLACK FOX"
Н	CROSSVILLE SPEAKEASY AV283, SWEET GEORGIA BROWN, WITH SAND BEIGE H148 GROUT (GC-T3)
J K	SHERWIN WILLIAMS: SW 7016 "MINDFUL GRAY" NATURAL CONCRETE, GRAY
L M	RAL-7039 QUARTZ GREY RAL-7022 UMBRA GREY
GENE	RAL NOTES:
1. 2.	ALL SIGNAGE IS UNDER SEPARATE SUBMITTAL AND PERMIT (N.I.C.). C.J. = PLASTER CONTROL JOINT
3.	ALL PLASTER ACCESSORIES, FLASHING ETC. SHALL BE PAINTED TO MATCH ADJACENT SURFACES.(U
4.	ALL EXTERIOR WALL OPENINGS FOR RECEPTACLES, HOSE BIBBS, ETC. SHALL BE SEALED. SEE FLOO PLAN, GENERAL NOTES, AND SPECIFICATIONS FOR ADDITIONAL NOTES.
5. 6.	R.J. = 3/4" PLASTER REVEAL JOINT SEE FINISH SCHEDULE ON SHEET A8.0, ID4.0, & ID4.2 FINISHES. INTERIOR FINISHES ARE
	DESIGNATED BY ##
7.	ALL OUTSIDE CORNERS WITH CROSSVILLE SPEAKEASY TO GET (GC-TR2B)



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6930 DESTINY DRIVE SUITE 100 ROCKLIN, CA 95677

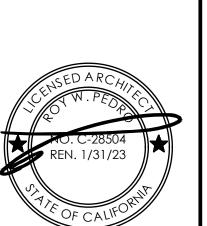(916) 415-5358 rpedro@pmdginc.com

Roy W. Pedro, Architect

SITE INFORMATION


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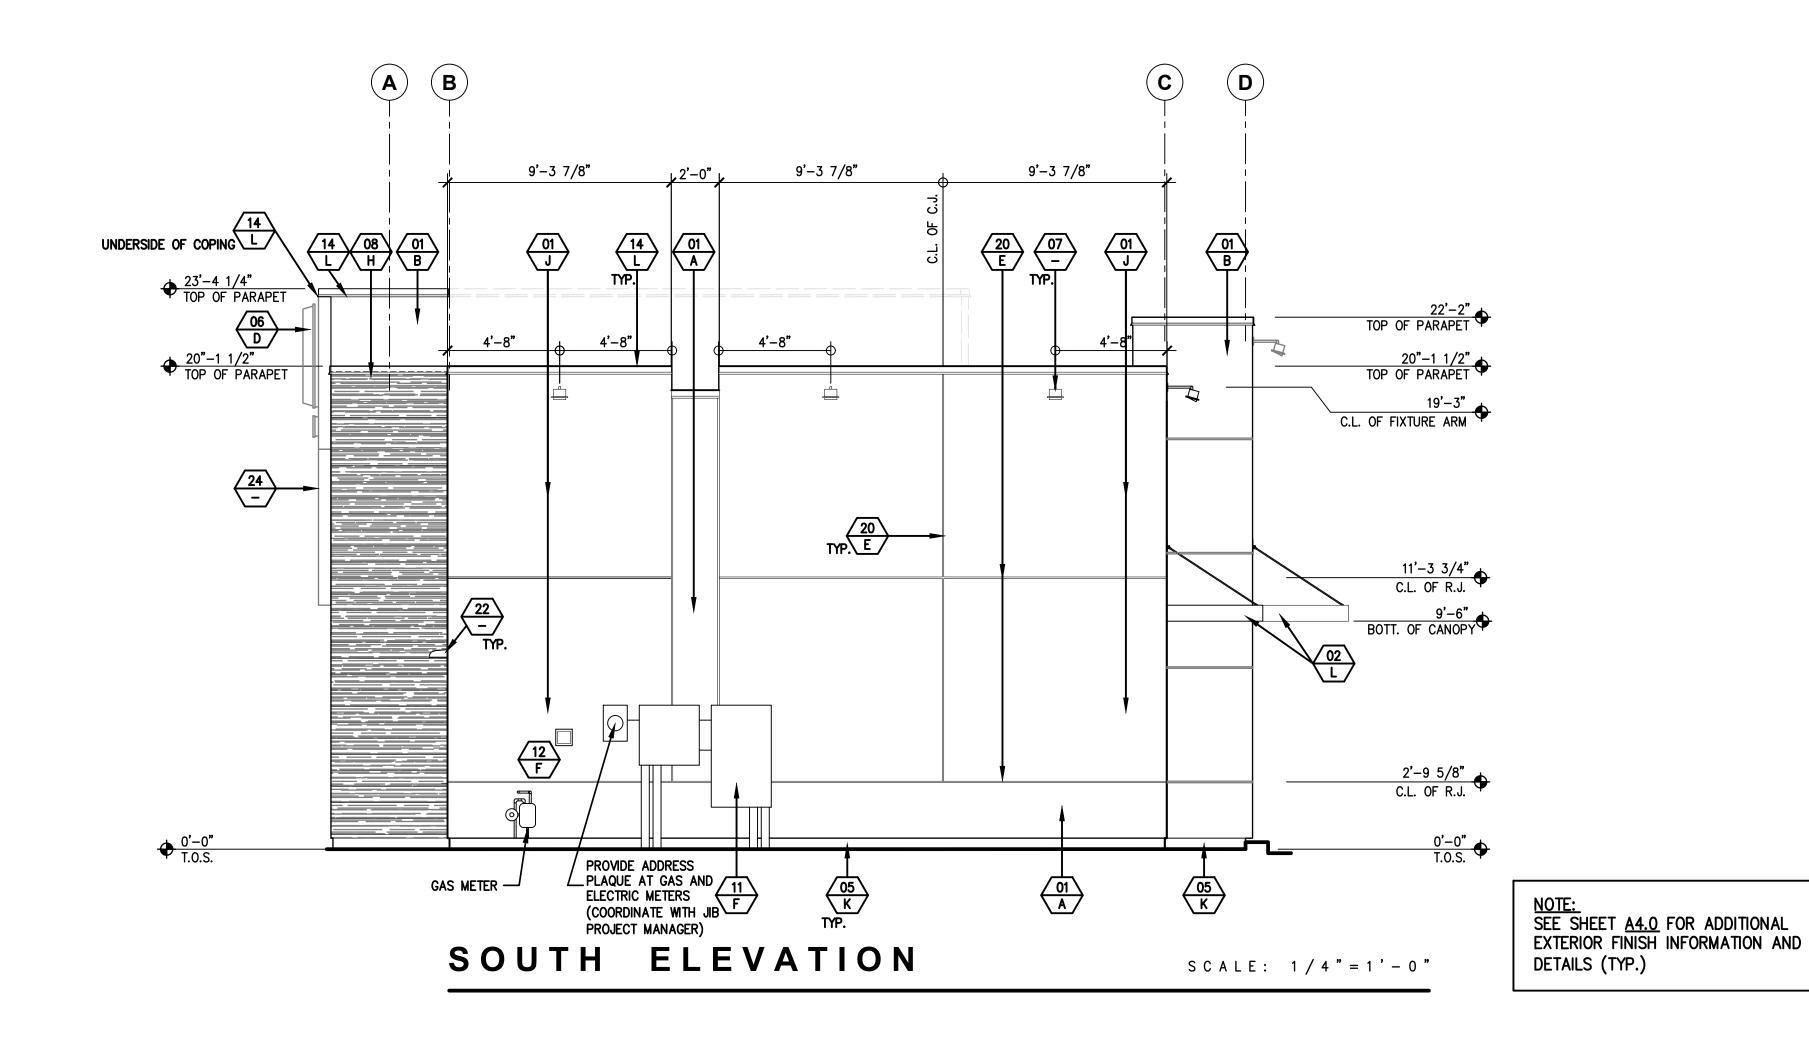
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PROJECT #: WFM20001.0 AS NOTED SCALE:

> **EXTERIOR ELEVATIONS**



S C A L E: 1 / 4 " = 1 ' - 0 "

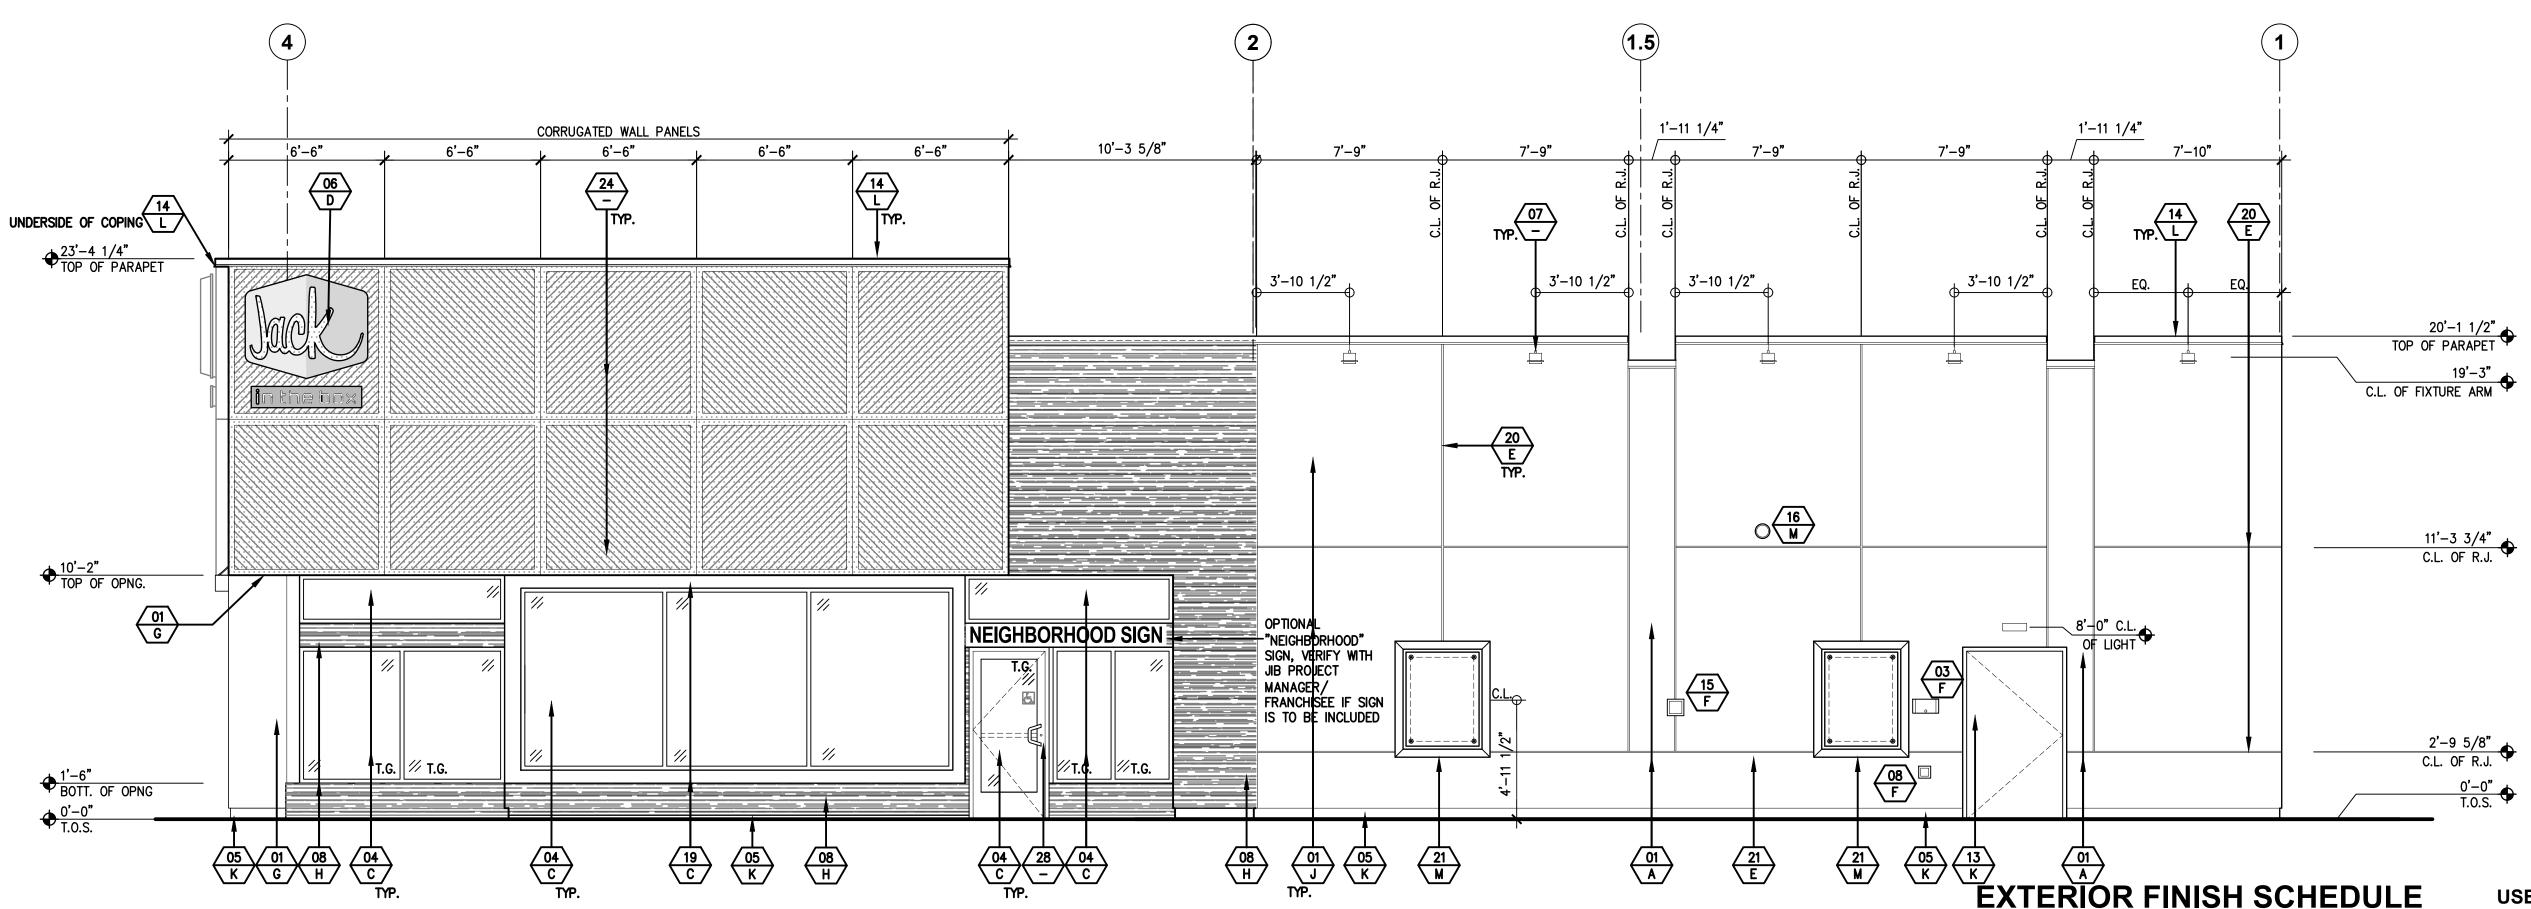

WEST ELEVATION

			2'-9 5/8" C.L. OF R.J.
	/	╽▐	
/			0'-0" T.O.S. ◆
	<del>(</del>	<u> 01</u>	
ΧT	EF	₹Ï	OR FINISH SCHEDULE USE CHECKED BOX ONLY
i\_			ERIAL/FINISH
ブー	— cc	DLO	DR CONTRACTOR CONTRACT
TER	IAL/F	INI	<u>ISH:</u>
l	EXTE	RIC	OR CEMENT PLASTER- SAND FLOAT FINISH (SEE SPECIFICATIONS)
	1	INT	TEGRAL COLOR
		SH	IERWIN WILLIAMS ACRYLIC COATING
			TERIOR INSULATION FINISHING SYSTEM (EIFS)
		AS	S ALTERNATE, CONTRACTOR TO SUBSTITUTE EIFS
2			LIEU OF EXTERIOR CEMENT PLASTER
2 3	GRE A	ING ASE	S/CANOPY & SUPPORTS (O.F.O.I) OF-EQ23 OF-EQ24 E TANK / BULK OIL SYSTEM BOX
4	ALUN	ININ	UM STOREFRONT SYSTEM (SEE SPECS FOR MORE INFORMATION)
	1	1"	" CLEAR INSULATED GLASS
	一		CLEAR INSULATED GLASS ANTI-GRAFFITI FILM
	Ш	W	SOLARBAN 60 COATING
5			OR CEMENT PLASTER FINISH COAT OVER CONCRETE CURB
5 7	WALL	KINA - M	ALLY ILLUMINATED SIGNAGE (O.F.O.I., NOT A PART OF THIS PERMIT) IOUNTED LIGHT FIXTURE, SEE DETAIL <u>16/A9.3</u> FOR FIXTURE ATTACHMENT.
3	8" P	OR	CELAIN WALL TILE
<b>∌</b> )			SED, LOCKABLE, NON—FREEZE HOSE—BIB ENCLOSURE IATED ADDRESS WITH 12" HIGH LETTERS (AS REQUIRED PER LOCAL JURISDICTION) (OF—EQU
	MAIN	l El	LECTRICAL SERVICE
<u> </u>			BLE, IRRIGATION CONTROL PANEL V METAL DOORS AND FRAMES, MISCELLANEOUS TRIM
ĺ	ALUN	ININ	UM COPING
7			LL BOX METAL COVER THRU/ CASHIER WINDOW
3			LIGHTING FIXTURE WITHIN CANOPY
)	FEAT	UR	RE WINDOW POP OUT W/ ALUMINUM BREAK METAL PANELS  LUMINUM PLASTER REVEAL
) 			Y POSTER PANEL & SURROUND, SEE DETAIL <u>2/A9.3</u> , <u>3/A9.3</u> , (0F-EQ18) & (0F-EQ19)
2	EXTE	RIC	OR WALL PACK LIGHT FIXTURE
3 4	NOT		SED GATED WALL PANELS (O.F.O.I) < (OF-EQ10)
5	FIBE	R C	CEMENT SIDING PANEL
3	SMO	OTH	H FINISH CONCRETE BASE



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SITE INFORMATION MK TYPE: MK9DS\_MD

JIB #: 4387 ADDRESS:

1240 W. WOOD ST. WILLOWS, CA 95988

DRAWN BY:

PROJECT #: WFM20001.0 SCALE: AS NOTED

> **EXTERIOR ELEVATIONS**

**A4.1** 

**GENERAL NOTES:** 

CLEAR ANODIZED

COLOR:

ALL SIGNAGE IS UNDER SEPARATE SUBMITTAL AND PERMIT (N.I.C.).

27 STEEL POST W/ CUSTOM LIGHT FIXTURE AND BANNER 28 DOOR PULL, SEE DOOR SCHEDULE OF-EQ13

SHERWIN WILLIAMS: SW 7020 "BLACK FOX" SHERWIN WILLIAMS: SW 6321 "REDBAY"

STANDARD STOREFRONT: CLEAR ANODIZED

COLOR/FINISH TO MATCH ADJACENT SURFACE

WHITE TEXT ON RED BACKGROUND

C.J. = PLASTER CONTROL JOINT

NATURAL CONCRETE, GRAY

RAL-7039 QUARTZ GREY

RAL-7022 UMBRA GREY

ALL PLASTER ACCESSORIES, FLASHING ETC. SHALL BE PAINTED TO MATCH ADJACENT SURFACES.(U.O.N.)

SHERWIN WILLIAMS: SW 7020 "BLACK FOX"
CROSSVILLE SPEAKEASY AV283, SWEET GEORGIA BROWN, WITH SAND BEIGE H148 GROUT GC-T3
SHERWIN WILLIAMS: SW 7016 "MINDFUL GRAY"

ALL EXTERIOR WALL OPENINGS FOR RECEPTACLES, HOSE BIBBS, ETC. SHALL BE SEALED. SEE FLOOR

PLAN, GENERAL NOTES, AND SPECIFICATIONS FOR ADDITIONAL NOTES. R.J. = 3/4" PLASTER REVEAL JOINT

SEE FINISH SCHEDULE ON SHEET A8.0, ID4.0, & ID4.2 FINISHES. INTERIOR FINISHES ARE

DESIGNATED BY ## 7. ALL OUTSIDE CORNERS WITH CROSSVILLE SPEAKEASY TO GET GC-TR2B



# EAST ELEVATION



NORTH ELEVATION







SITE	NFORMATION
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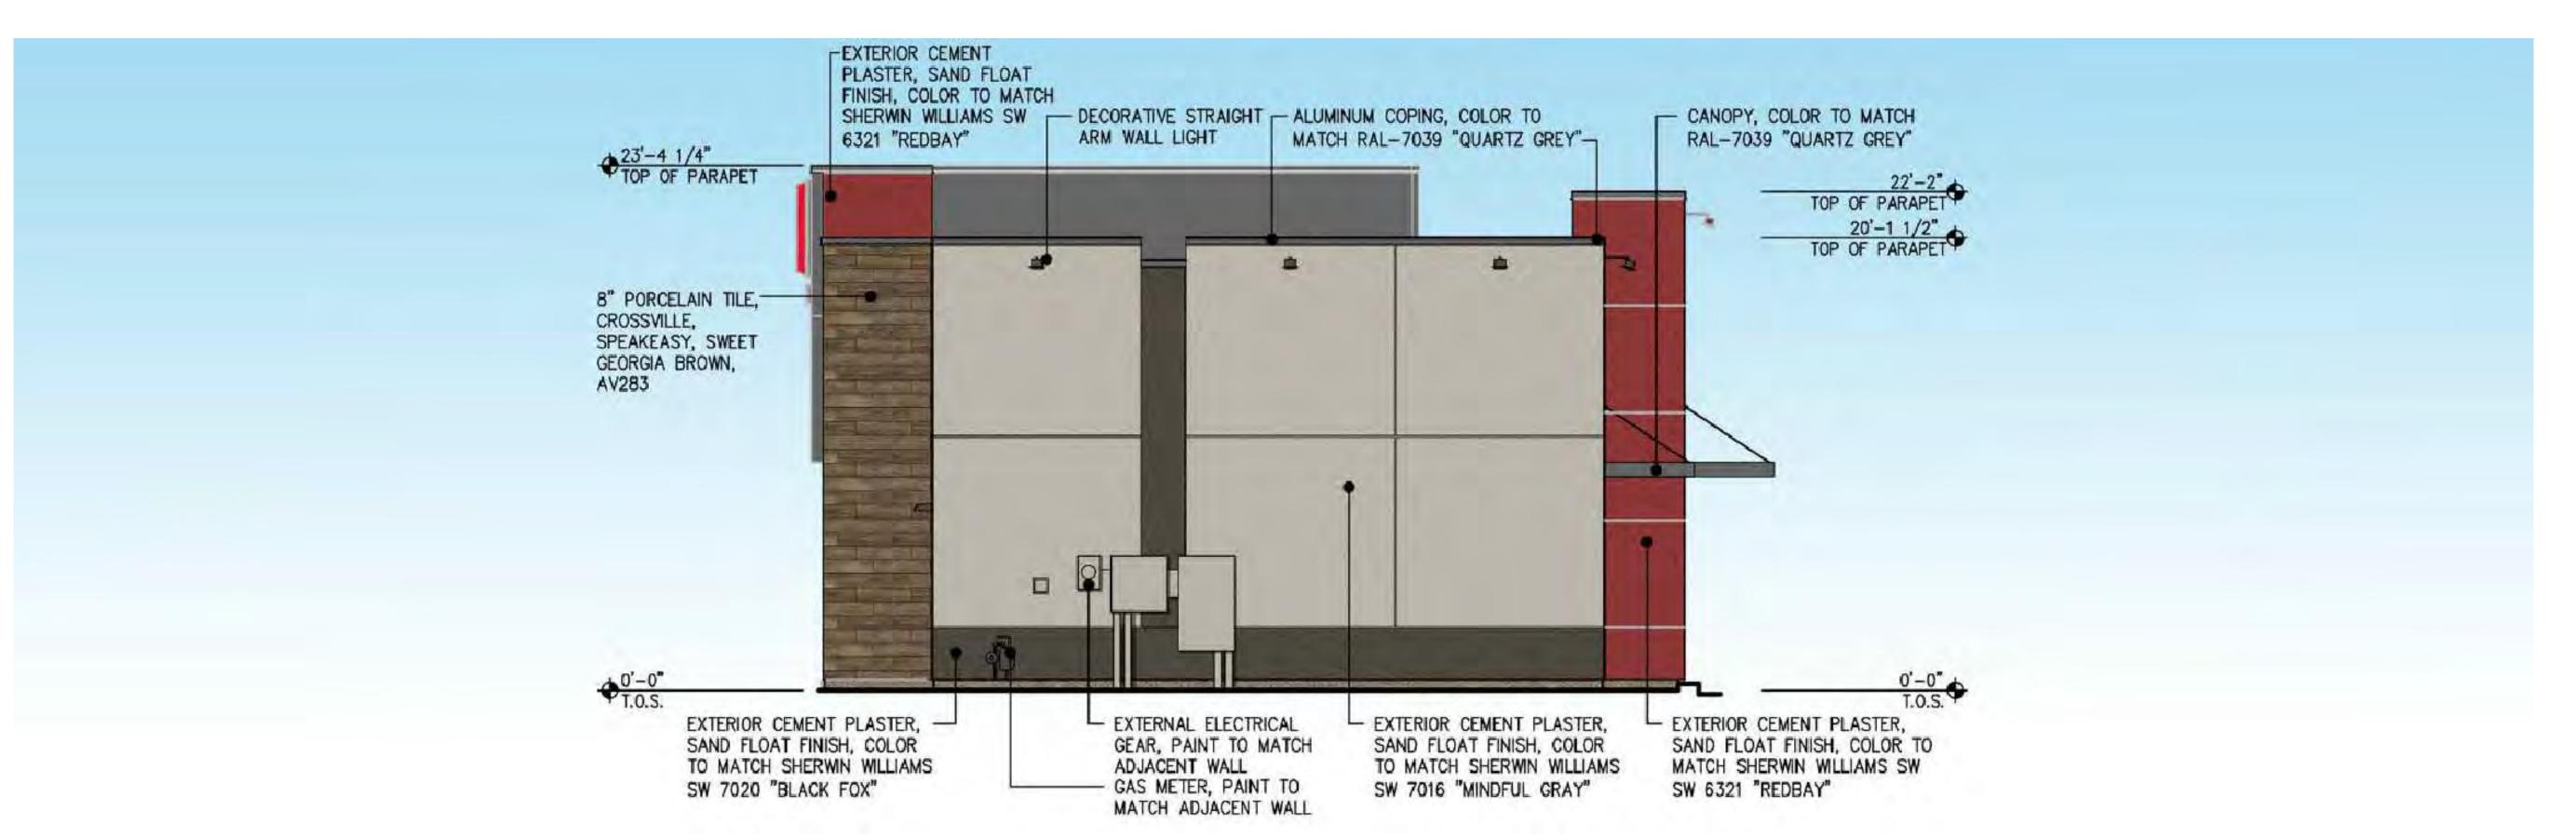
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PROJECT #: WFM20001.0

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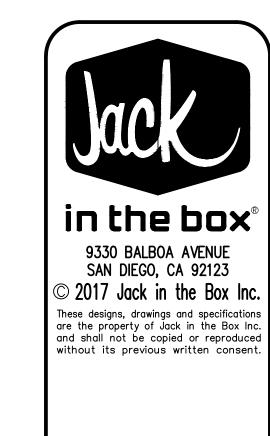
SCALE: AS NOTED

COLOR ELEVATIONS A4.2






SOUTH ELEVATION



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SITE INFORMATION
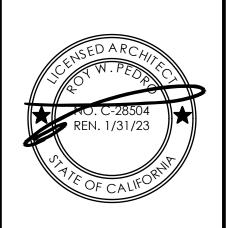
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WILLOWS, CA 95988

DRAWN BY: PROJECT #: WFM20001.0 SCALE: AS NOTED

> **EXTERIOR** COLOR

**ELEVATIONS A4.3** 

# **GENERAL NOTES**

- 1. SEE FINISH SCHEDULE / I.D. DRAWINGS FOR INFORMATION ON INTERIOR FINISHES. INTERIOR FINISHES ARE DESIGNATED BY;
- 2. ATTACH TABLE TOPS TO BASES PER MANUFACTURER'S REQUIREMENTS / INSTRUCTIONS.
- 3. RESTROOM VESTIBULE ELEVATIONS ARE SHOWN ON SHEET <u>ID2.0.</u>
- 4. RESTROOM ELEVATIONS ARE SHOWN ON SHEET A7.0.
- 5. WORKSTATION & EMPLOYEE ROOM ELEVATIONS ARE SHOWN ON SHEET K2.2.
- 6. KITCHEN ELEVATIONS ARE SHOWN ON SHEET K2.0 & K2.1.
- 7. ALL EXPOSED FINISH CORNERS AND SEAMS REQUIRE CAULKING. IN ADDITION, BUT NOT LIMITED TO, TOP OF ALL COVE BASES, ALL FIXED EQUIPMENT, ETC. DO NOT APPLY CAULKING TO ANY V.W.C. SURFACE.
- 8. SEATING LAYOUT TO COMPLY WITH ALL APPLICABLE CODES AND ORDINANCES.
- 9. ALL DIMENSIONS ARE TO FACE OF FINISHED DRYWALL AND ARE CONSIDERED CRITICAL U.O.N. THE GENERAL CONTRACTOR SHALL VERIFY ALL DIMENSIONS WITH SHOP DRAWINGS AND PLANS AGAINST REQUIRED CLEARANCES.
- 10. IT SHALL BE THE GENERAL CONTRACTOR'S RESPONSIBILITY TO VERIFY ALL QUANTITIES BEFORE ORDERING AND INSTALLING MATERIAL.
- 11. SEE DETAIL SHEETS FOR BLOCKING AT COUNTER TOPS.
- 12. FOR CORE DRILLED TABLE BASES, SEE DETAIL 10/ID3.1.
- 13. PROVIDE 2X BLOCKING AT FRAMED WALLS FOR BOOTH ATTACHMENT. VERIFY EXACT LOCATION WITH BOOTH MANUFACTURER.
- 14. CORE DRILLING DIMENSIONS ARE NOTED WITH A C.D. AND SHOULD BE VERIFIED PRIOR TO DRILLING ONCE EQUIPMENT IS ON SITE.
- 15. PROVIDE WINDOW SHADES ITEM #OF-EQ6 ON ALL WINDOWS EXCEPT CASHIER AND PICKUP PASS THRU WINDOWS. VERIFY LOCATIONS WITH CONSTRUCTION MANAGER AND OWNER AND FIELD VERIFY SIZES PRIOR TO ORDERING.



in the box® 9330 BALBOA AVENUE

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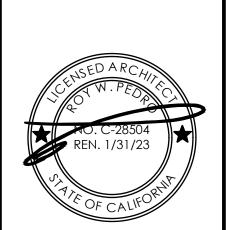
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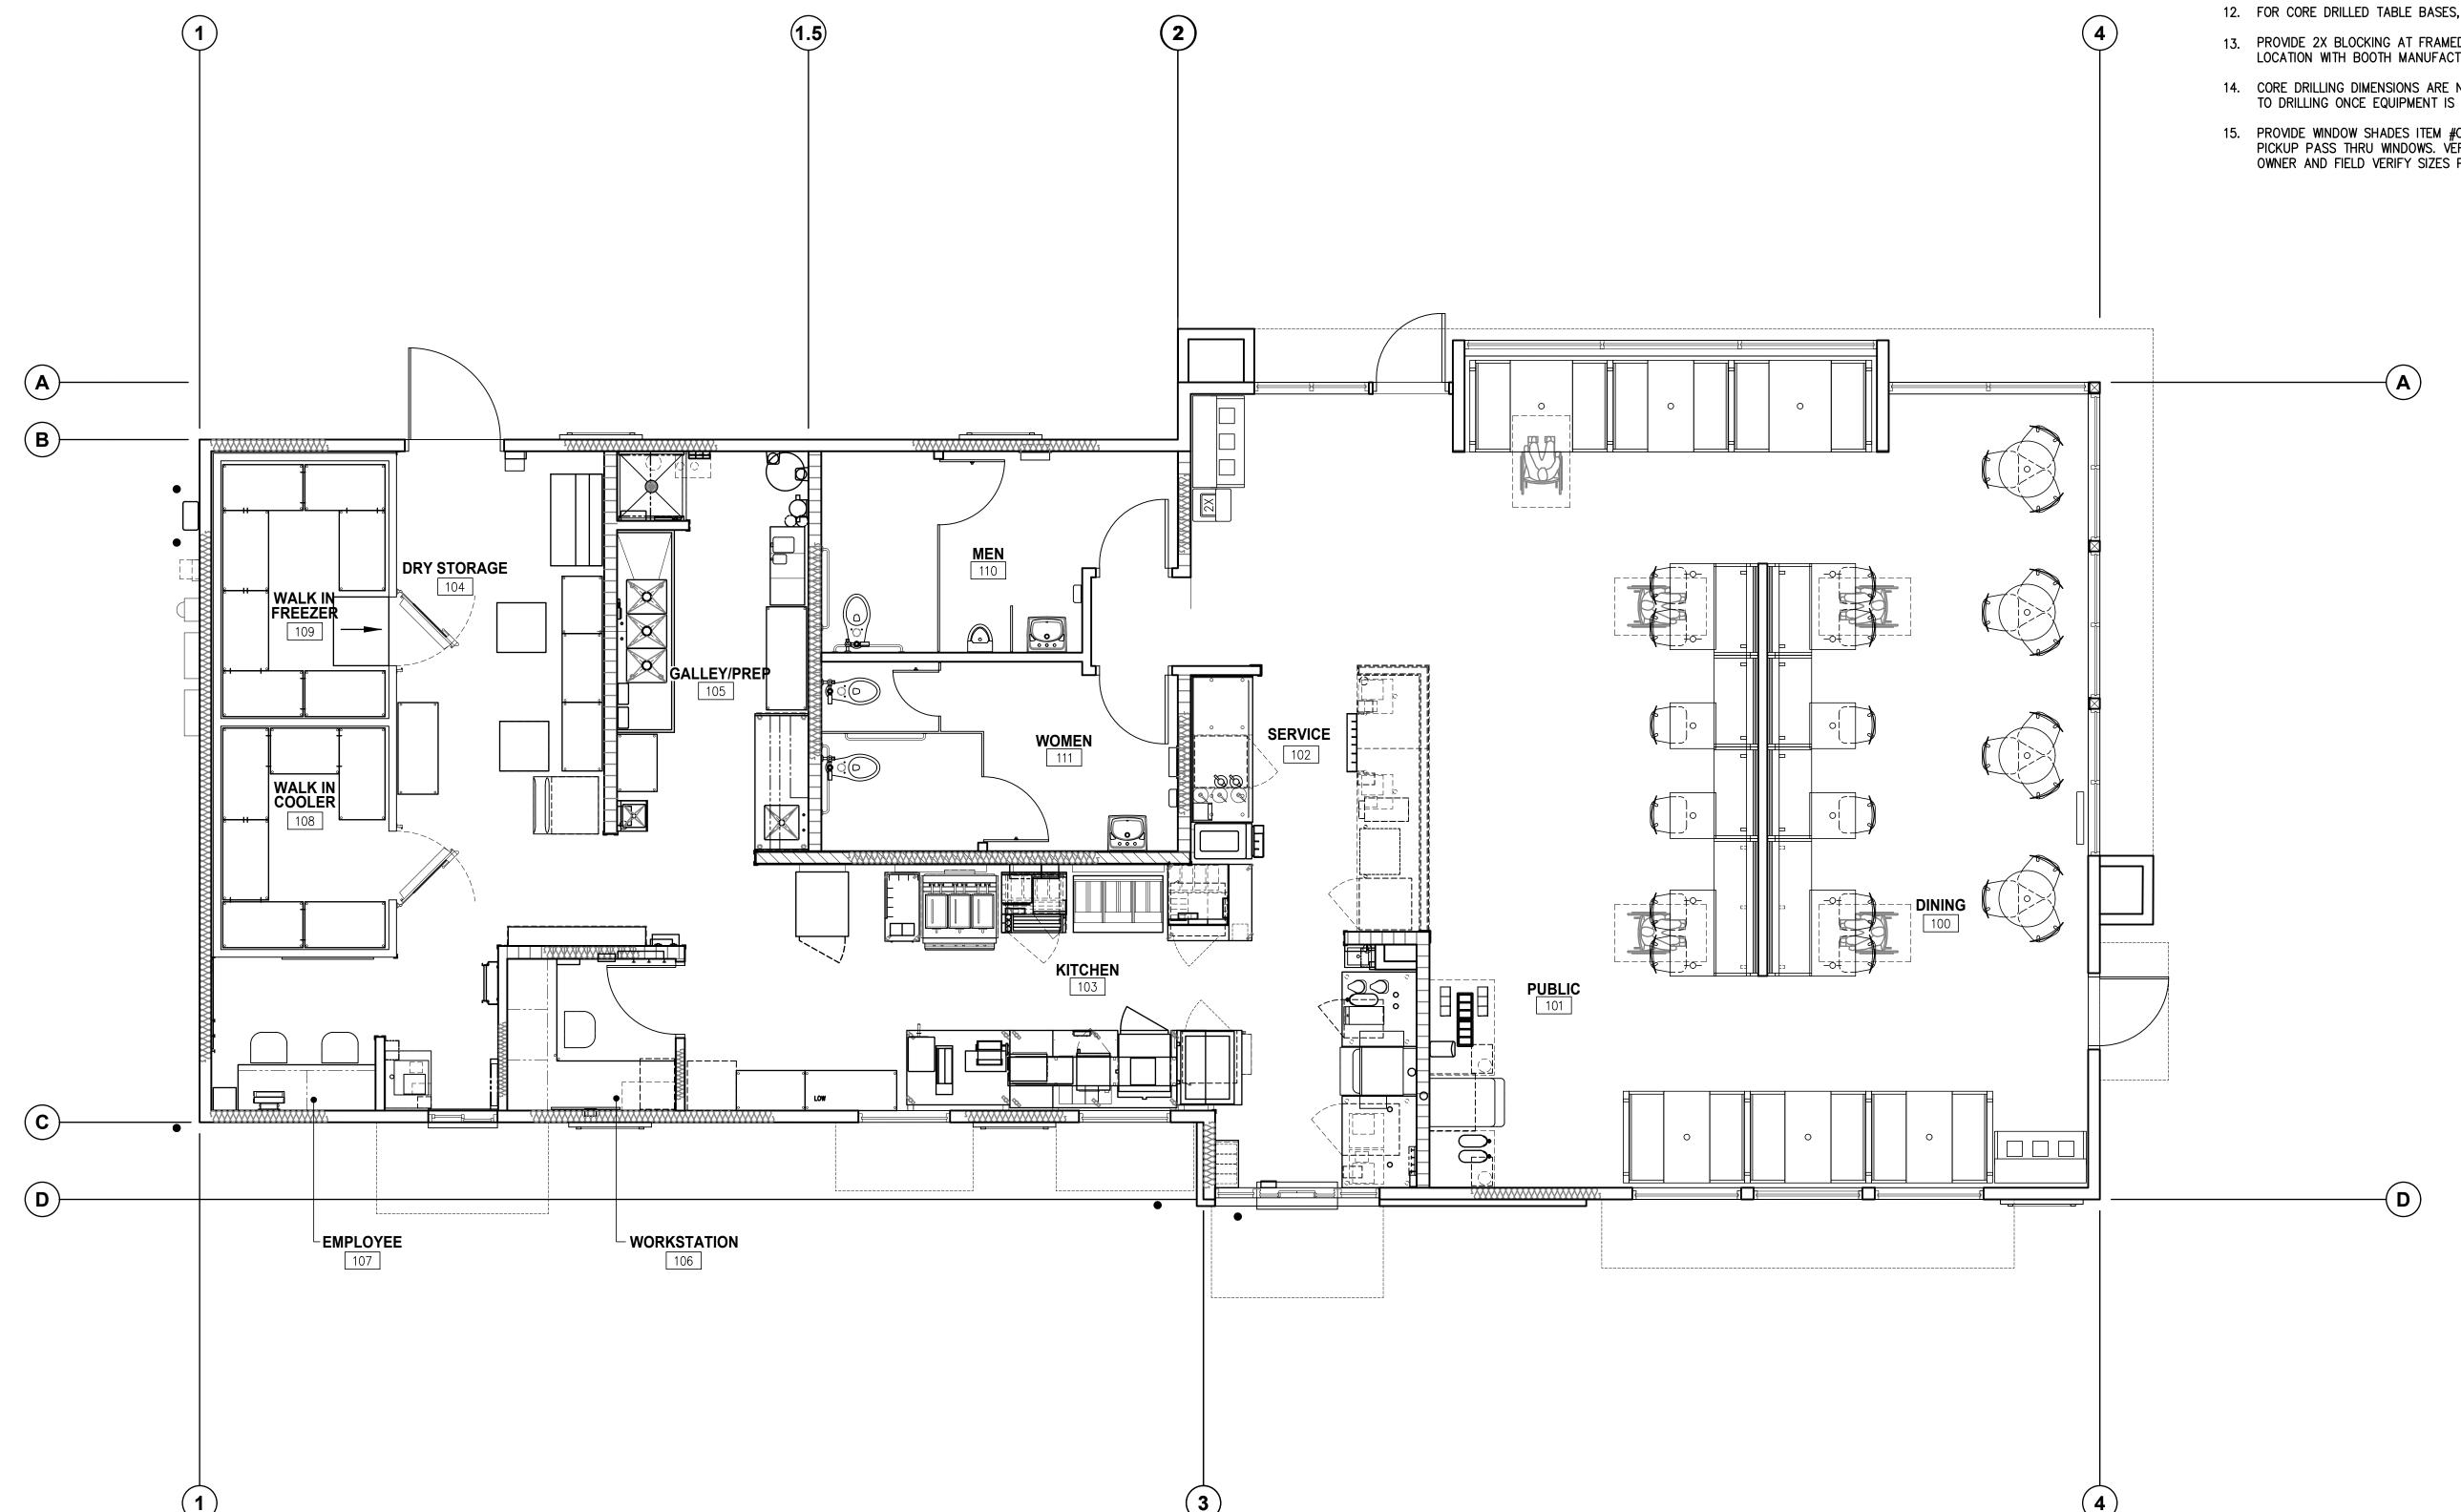
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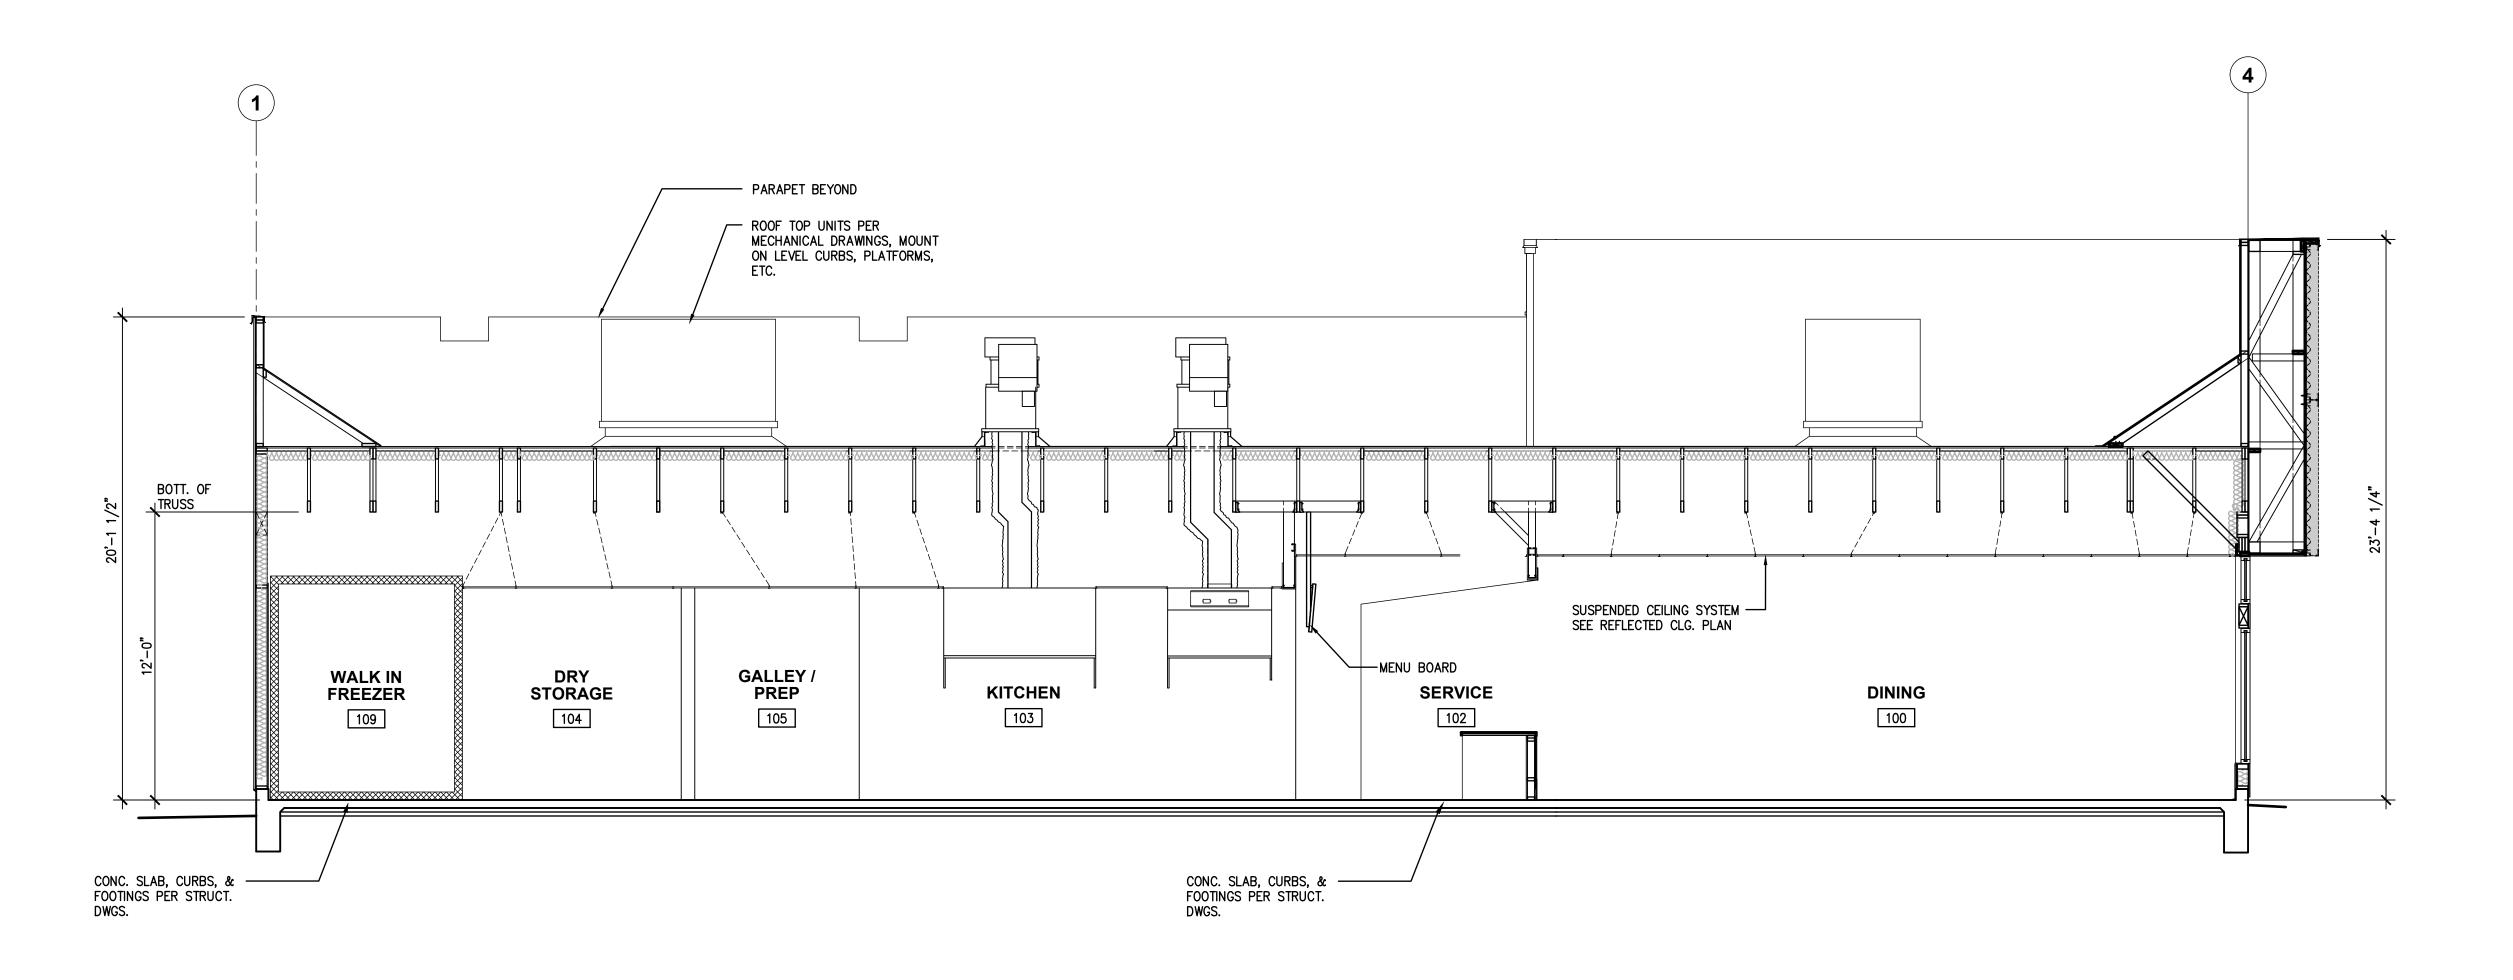
1240 W. WOOD ST. WILLOWS, CA 95988


DRAWN BY:

PROJECT #: WFM20001.0 SCALE: 1/4" = 1'-0"


**FURNITURE PLAN** 






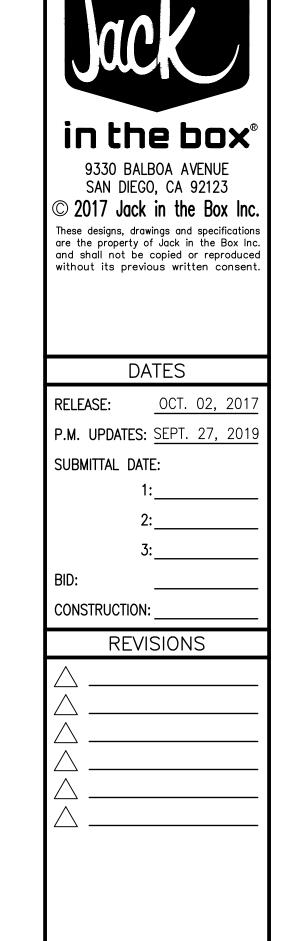

1) BUILDING LONGITUDINAL SECTION

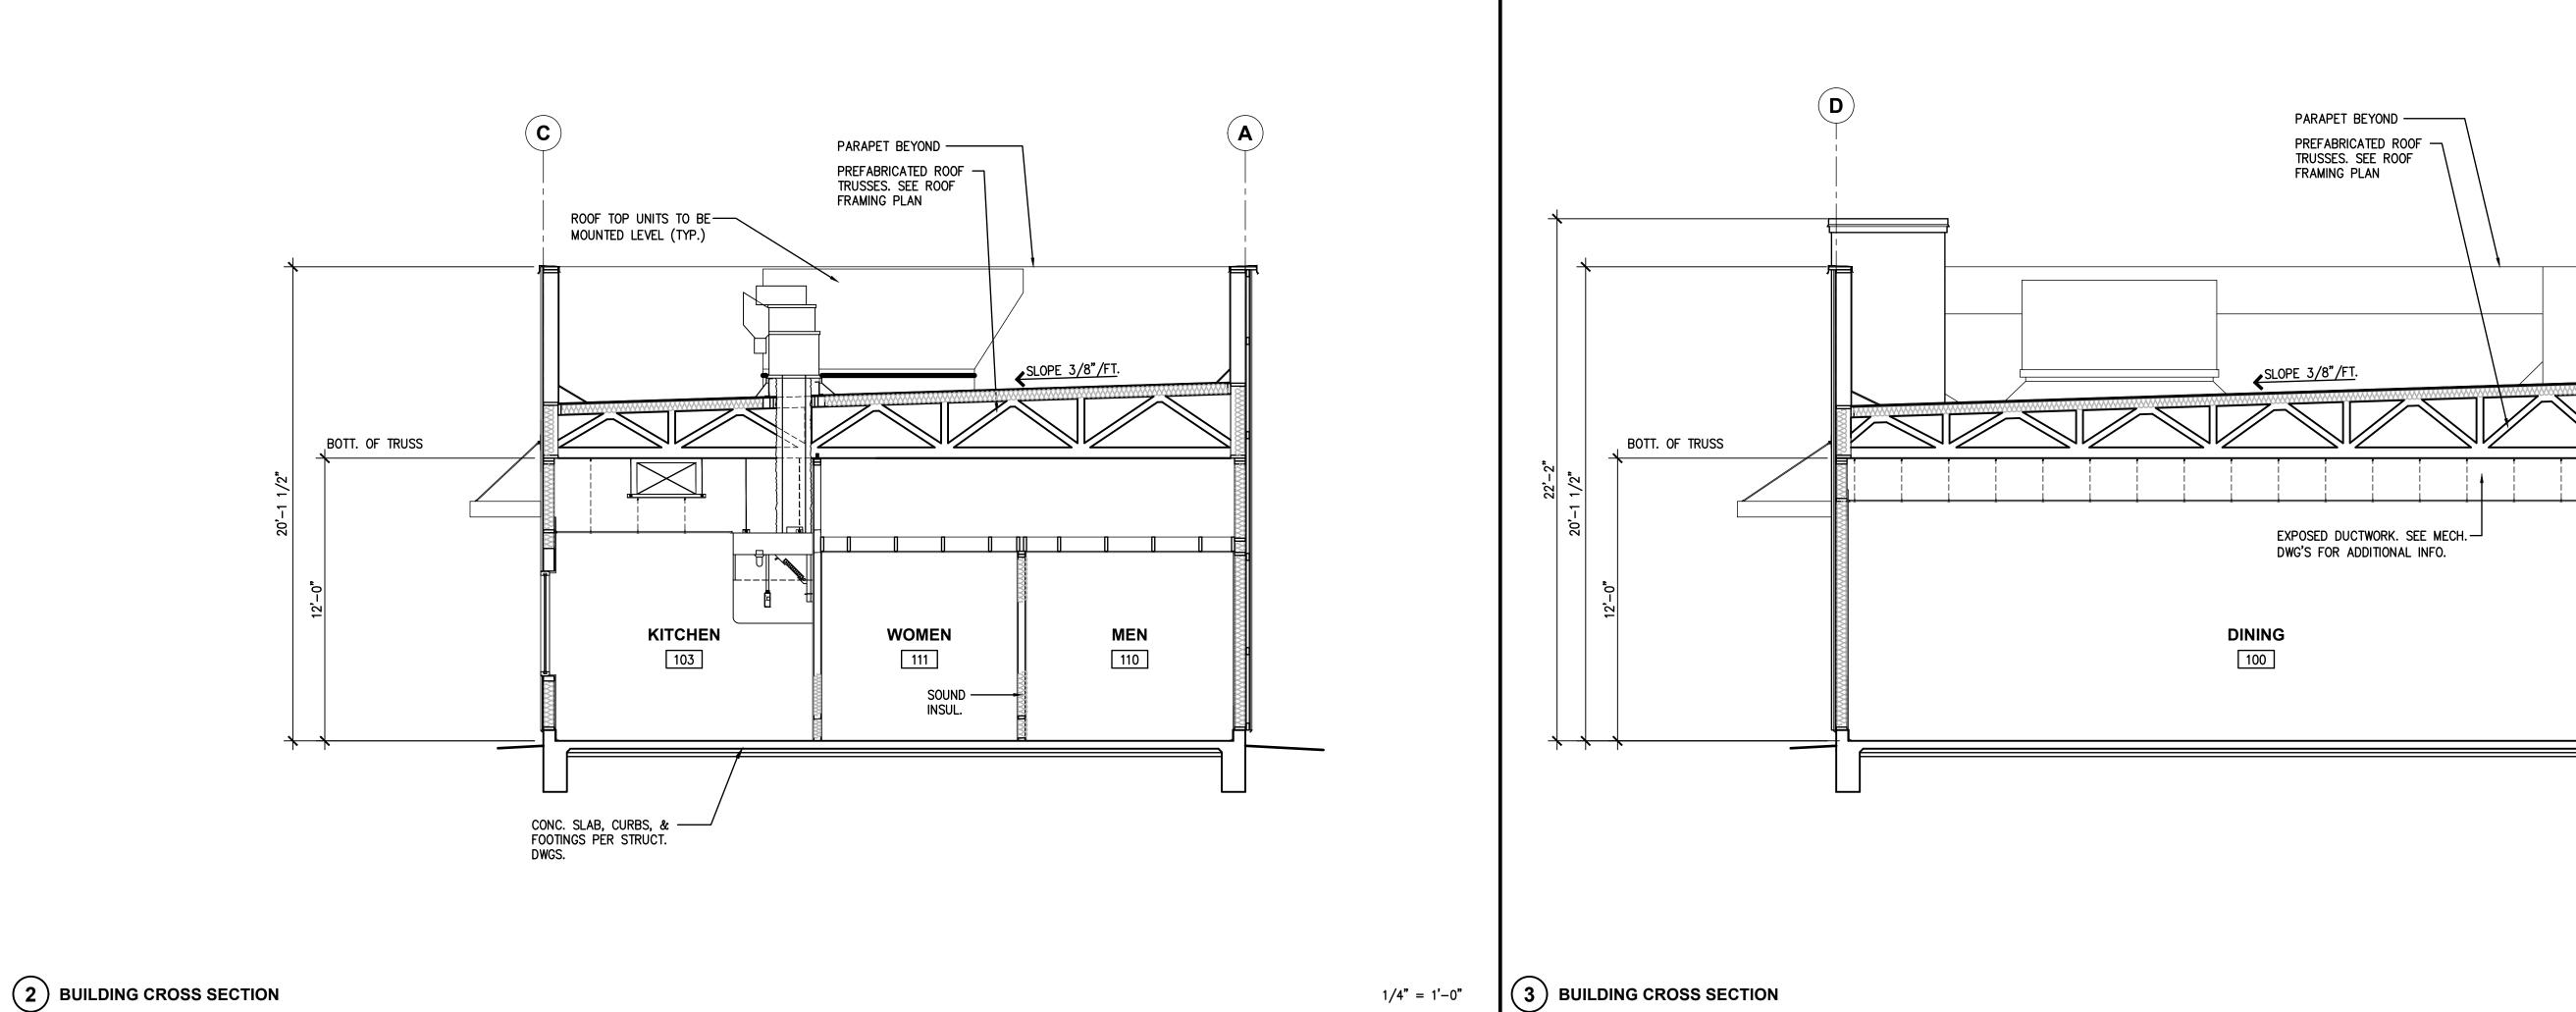

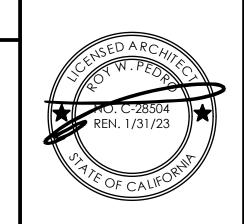



(916) 415-5358 rpedro@pmdginc.com Roy W. Pedro, Architect

SITE INFORMATION

MK TYPE: MK9DS\_MD

JIB #: 4387

ADDRESS: 1240 W. WOOD ST. WILLOWS, CA 95988

DRAWN BY:


1/4" = 1'-0"

PROJECT #: WFM20001.0

SCALE: AS NOTED

BUILDING SECTIONS

A5.0

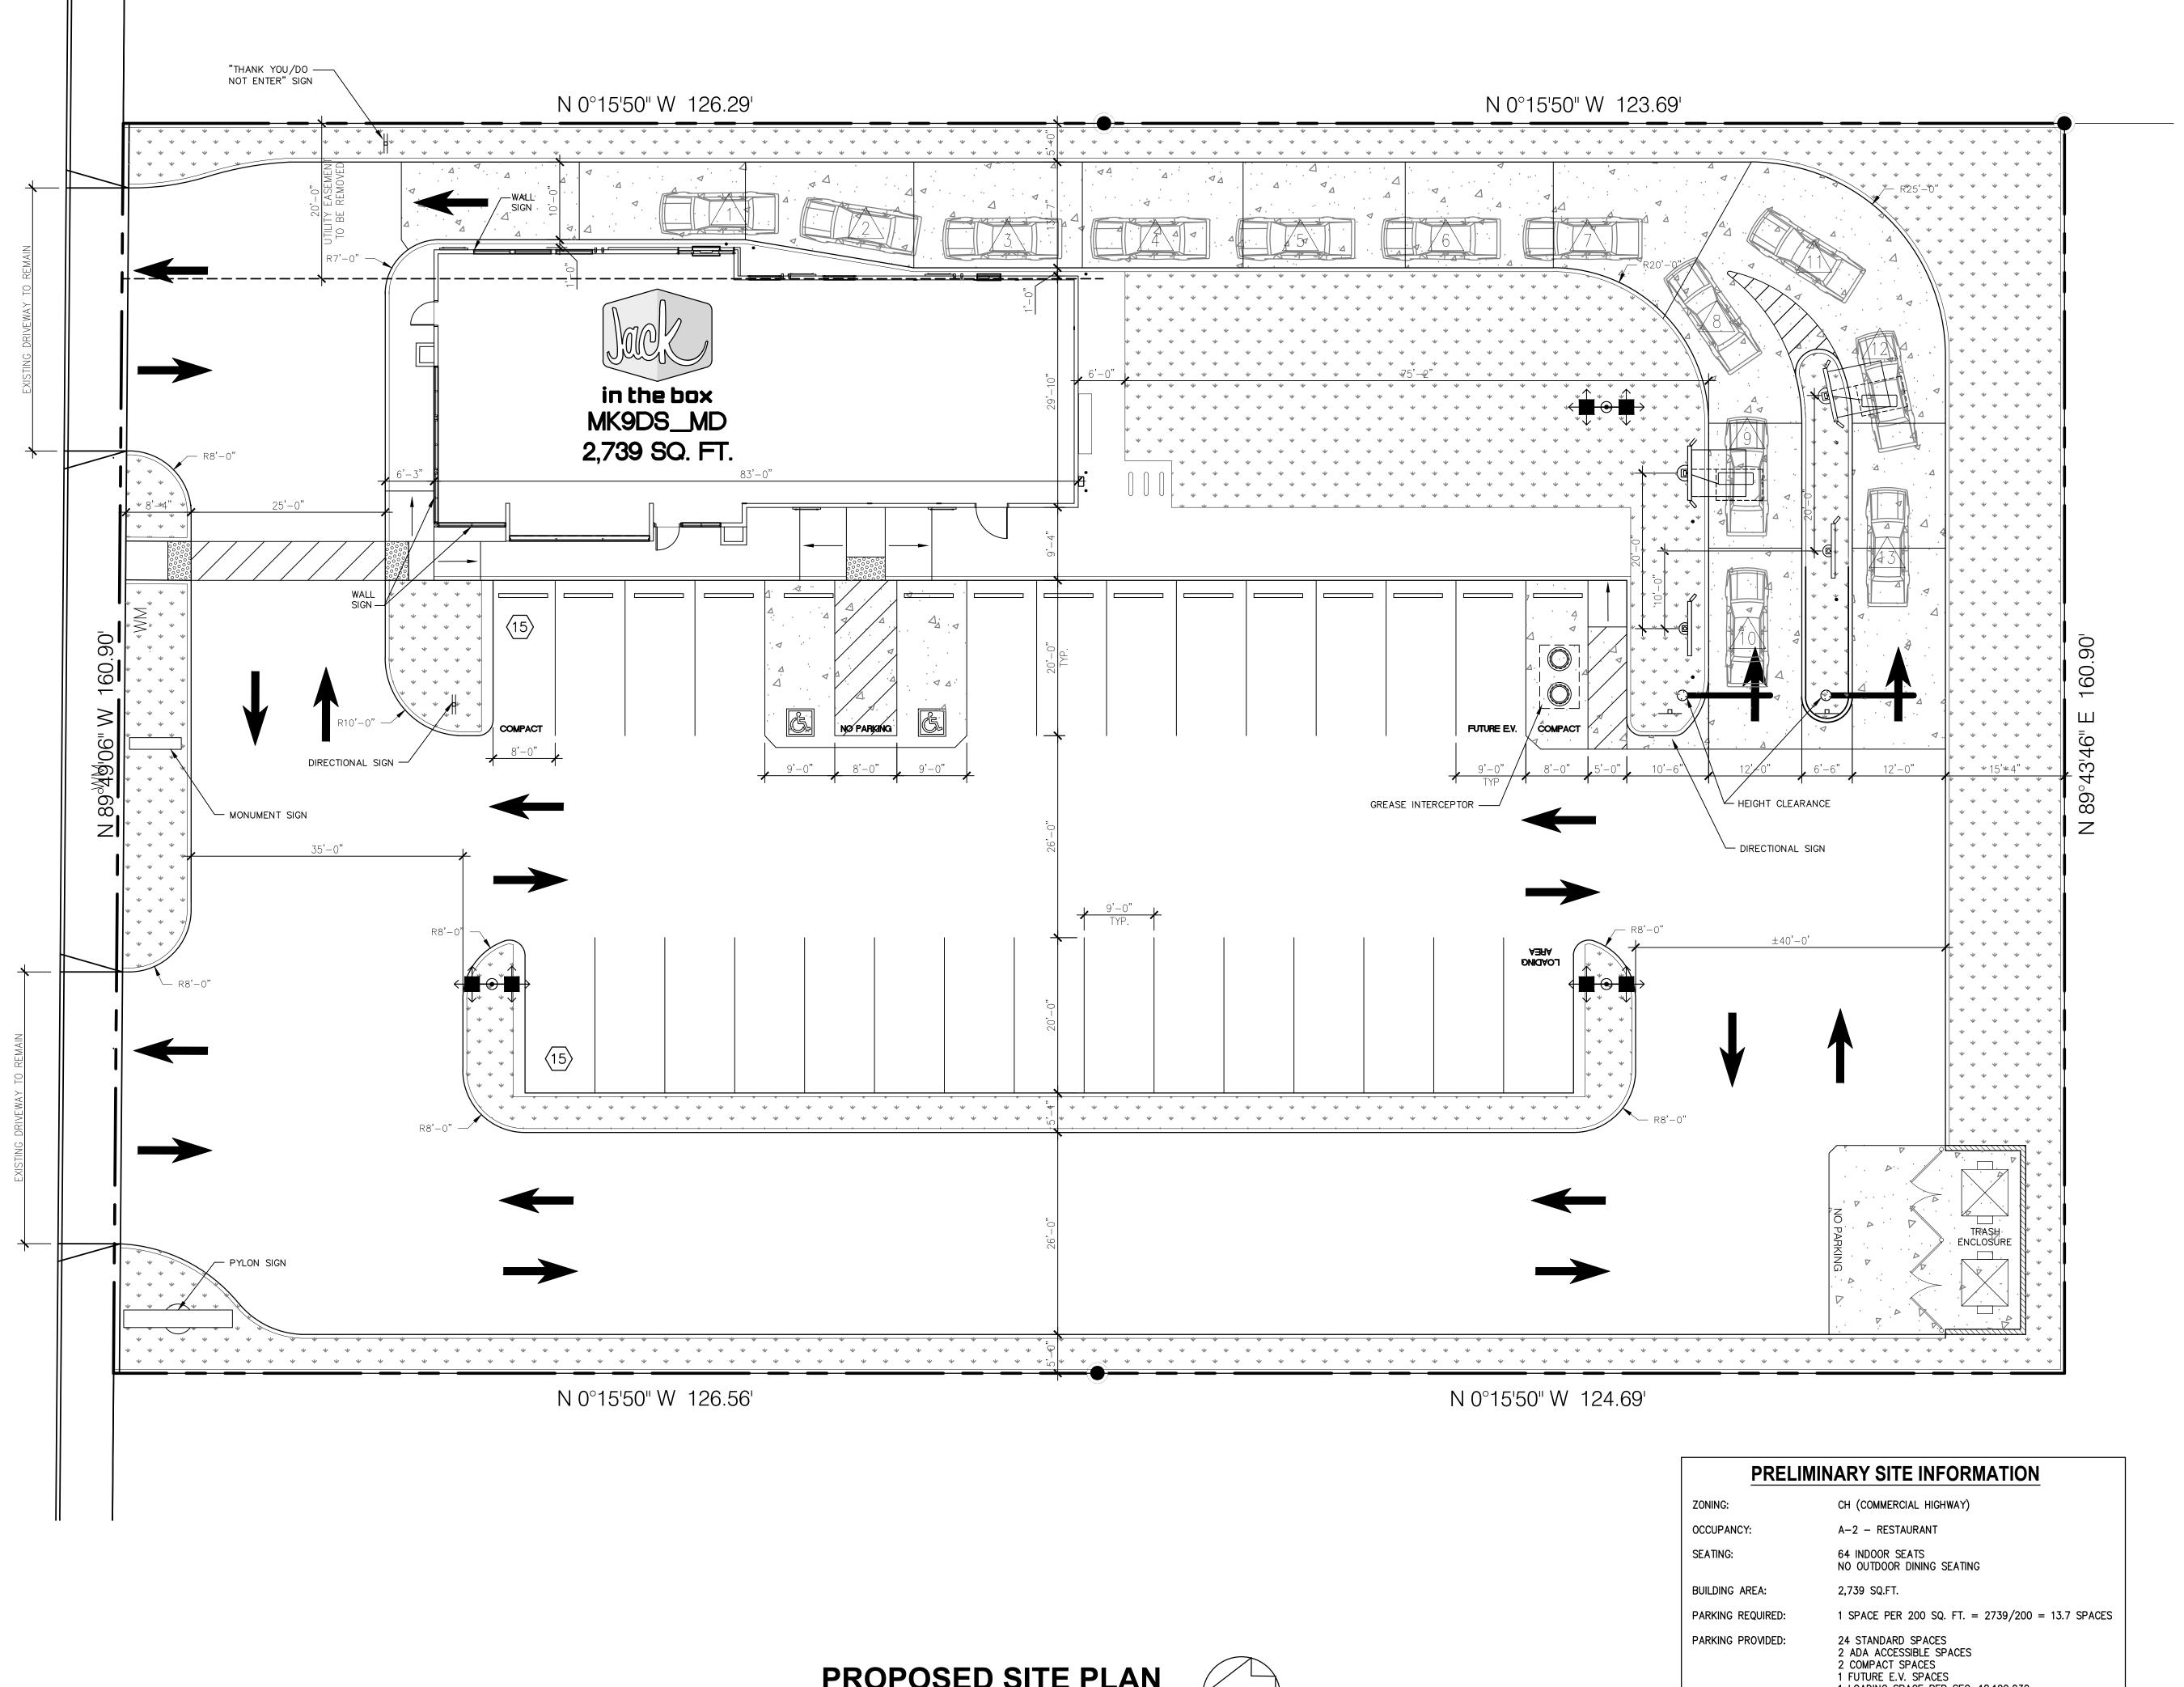

PROPOSED SITE PLAN

NORTH

SCALE: 1" = 10'



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DATES

without its previous written consent

**RELEASE:** OCT. 02, 2017 P.M. UPDATES: <u>SEPT. 27, 2019</u>

SUBMITTAL DATE:

CONSTRUCTION:

**REVISIONS** 



SUITE 100 ROCKLIN, CA 95677 (916) 415-5358 rpedro@pmdginc.com

SITE INFORMATION

Roy W. Pedro, Architect

MK TYPE: MK9DS\_MD

JIB #: <u>438</u>7

ADDRESS: 1240 W. WOOD ST.

WILLOWS, CA 95988

DRAWN BY:

PROJECT #: WFM20001.0

SCALE: 1" = 10'**PROPOSED** SITE PLAN

PARKING PROVIDED:

1 LOADING SPACE PER SEC. 18.120.030

30 TOTAL SPACES

#### REVISED LANDSCAPE PLAN

# TREES QTY BOTANICAL / COMMON NAME 10 Lagerstroemia indica `Red Rock

PLANT SCHEDULE

<u>SHRUBS</u>

Lagerstroemia indica `Red Rocket` / Crape Myrtle15 gal Low

CONT WUCOLS

5 gal Low

SCALE: 1/16" = 1'-0"

3 Ulmus x `Frontier` / American Elm 15 gal Moderate

Zelkova serrata `Village Green` / Sawleaf Zelkova 15 gal Moderate

QTYBOTANICAL / COMMON NAMECONTWUCOLS138Callistemon viminalis `Little John` / Dwarf Weeping Bottlebrush5 galLow

95 Dietes x `Lemon Drop` / Fortnight Lily 5 gal. Low

98 Grevillea x `Noellii` / Grevillea 5 gal Low

68 Phormium x `Dark Delight` / Dark Delight Purple Flax 5 gal. Low

40 Rhaphiolepis umbellata `Eleanor Tabor` / Yedda Hawthorn

63 Yucca x `Bright Star` / Variegated Spanish Dagger 5 gal Low

GROUND COVERS QTY BOTANICAL / COMMON NAME CONT WUCOLS SPACE

24 Myoporum parvifolium / Trailing Myoporum 1 gal Low 60" o.c.

192 Rosa x `Red Drift` / Drift Rose 1 gal. Low 30" o.c.




- 1. All landscape planting areas shall receive a minimum 3" layer of organic mulch top dressing.
- 2. All trees, shrubs and groundcover shall be irrigated with a drip system, smart controller, weather sensor, etc.and shall meet City of Willows Water Efficient standards/regulations.
- 3. All new trees located within 7' of pavement or permanent structure shall have a root barrier.

## COMPLIANCE STATEMENT

I have complied with the criteria of the water use ordinance and applied them accordingly for the efficient use of water in the landscape design plan.



3-4-21

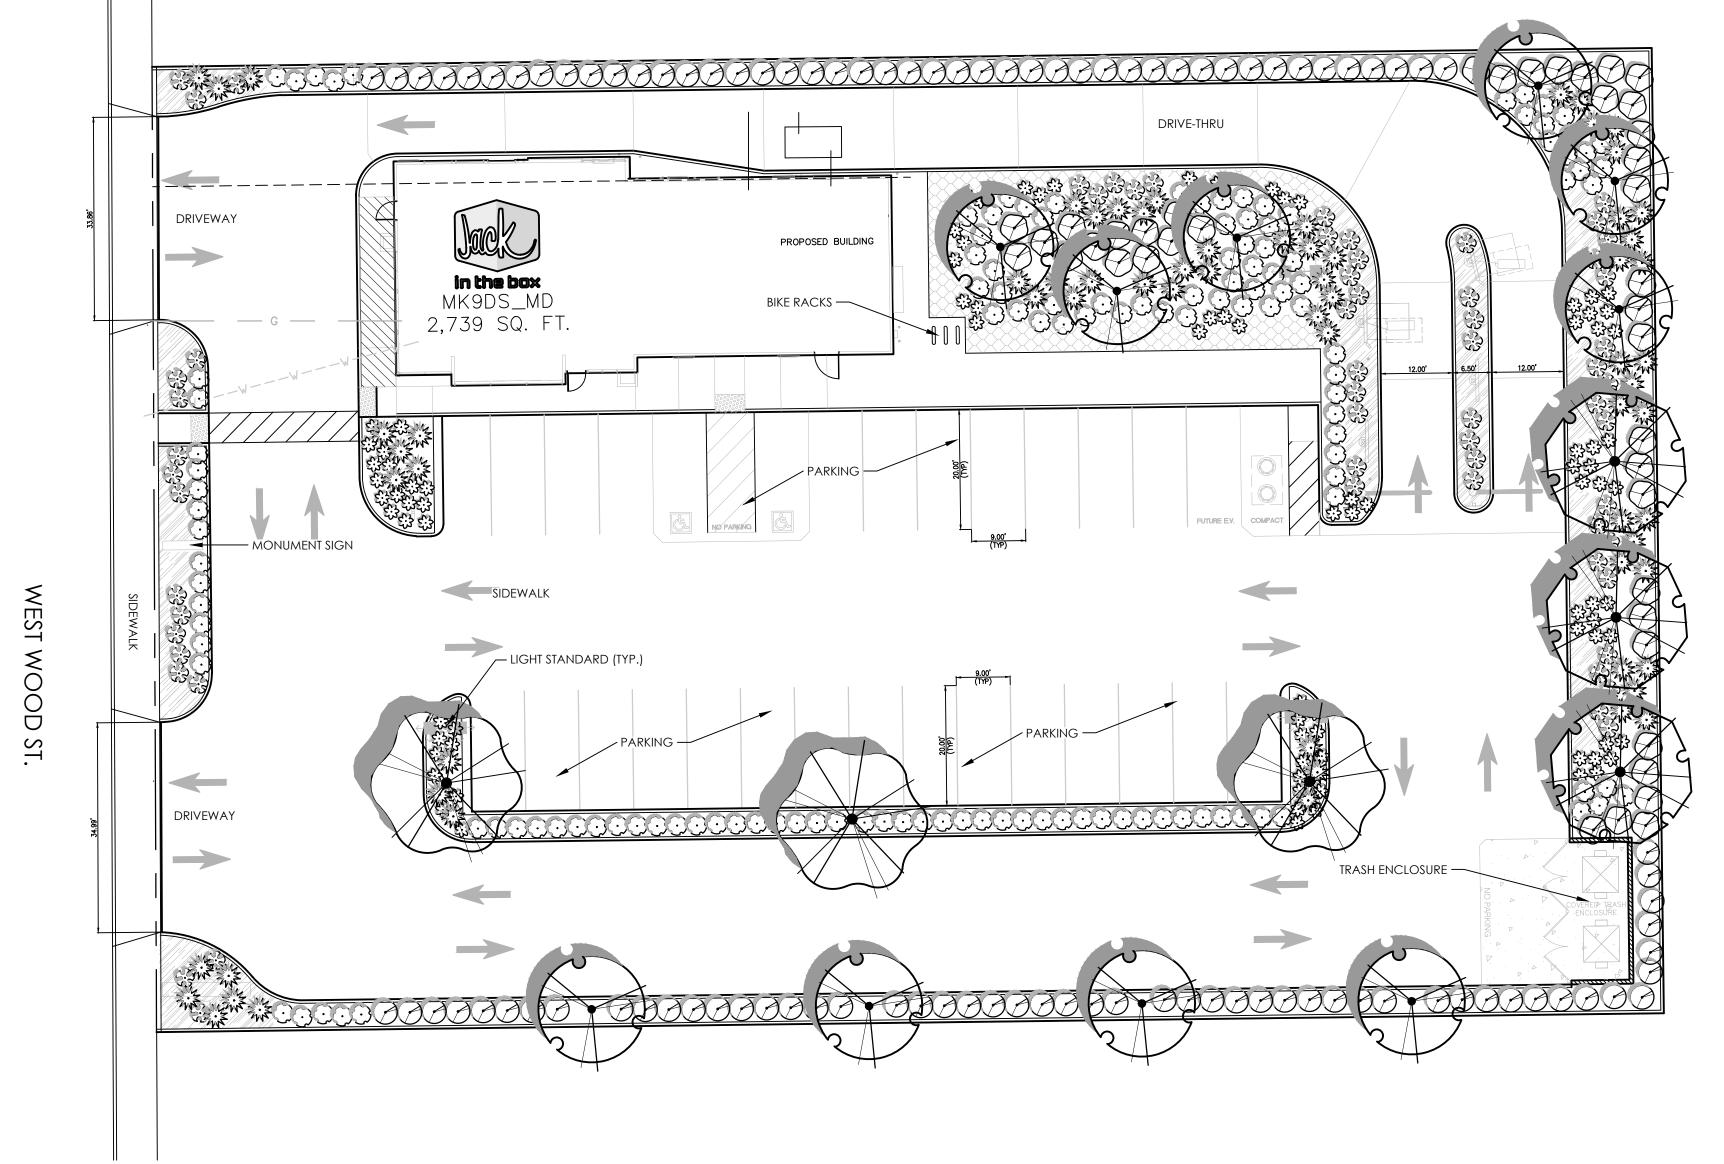

## Water Efficient Landscape Worksheet

HYDROZONE/PLANTING DESCRIPTION	PLANT FACTOR (PF)	IRRIG. METHOD	IRRIG. EFFICIENCY (IE)	ETAF (PF/IE)	LANDSCAPE AREA (Sq. Ft.)	ETAF x AREA	ESTIMATED TOTAL WATER USE (ETWU)
REGULAR LANDSCAPE AREA							
LOW WATER USE PLANTS	.3	DRIP	.81	.37	8,305	3,073	97,740 GAL.
MODERATE WATER USE PLANTS	.5	DRIP	.81	.62	125	78	2,481 GAL.
				TOTALS	(A) 8,430	(B)3,151	
					E	TWU Total	100,221GAL.

Maximum Applied Water Allowance (MAWA). MAWA= (ETO) (Conversion factor) ((ETAF) (Landscape Area)) + ((1-ETAF) x SLA) (51.3) (.62) (.45 x 8,430) + (1-.45) X 0) = 120,656 GALLONS

Estimated Total Water use (ETWU). ETWU= (ETo)) (Conversion factor) ((ETAF) (Area)) (51.3) (.62) (3,151) = 100,221 GALLONS

## ETAF Calculations

Regular Landscape Areas

otal ETAF x Area	(B) 3,151	
otal Area	(A) 8,430	
verage ETAF	(B / A) .37	

Note:
1. Average ETAF for Regular Landscape
Areas must be below .55 for residential
areas and .45 for non-residential areas.



9330 BALBOA AVENUE SAN DIEGO, CA 92123

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DATES

 RELEASE:
 OCT. 02, 2017

 P.M. UPDATES:
 SEPT. 27, 2019

**SUBMITTAL DATE: 1:** 7/14/21

2:\_\_\_\_\_ 3:

CONSTRUCTION:

REVISIONS

OLIVE STREET
LANDSCAPE ARCHITECTURE

P.O. Box 2083
Petaluma CA 94952
707-280-8990
OliveStreetLandscape.com
rod@olivestreetlandscape.com





(916) 415-5358 rpedro@pmdginc.com Roy W. Pedro, Architect

6930 DESTINY DRIVE SUITE 100 ROCKLIN, CA 95677

SITE INFORMATION

MK TYPE: MK9DS\_MD

JIB #: 4387

ADDRESS:
1240 W. WOOD ST.
WILLOWS, CA 95988

......


PROJECT #: WFM20001.0

SCALE: <u>1" = 16'</u>

LANDSCAPE PLAN

L1

## PLANT SCHEDULE

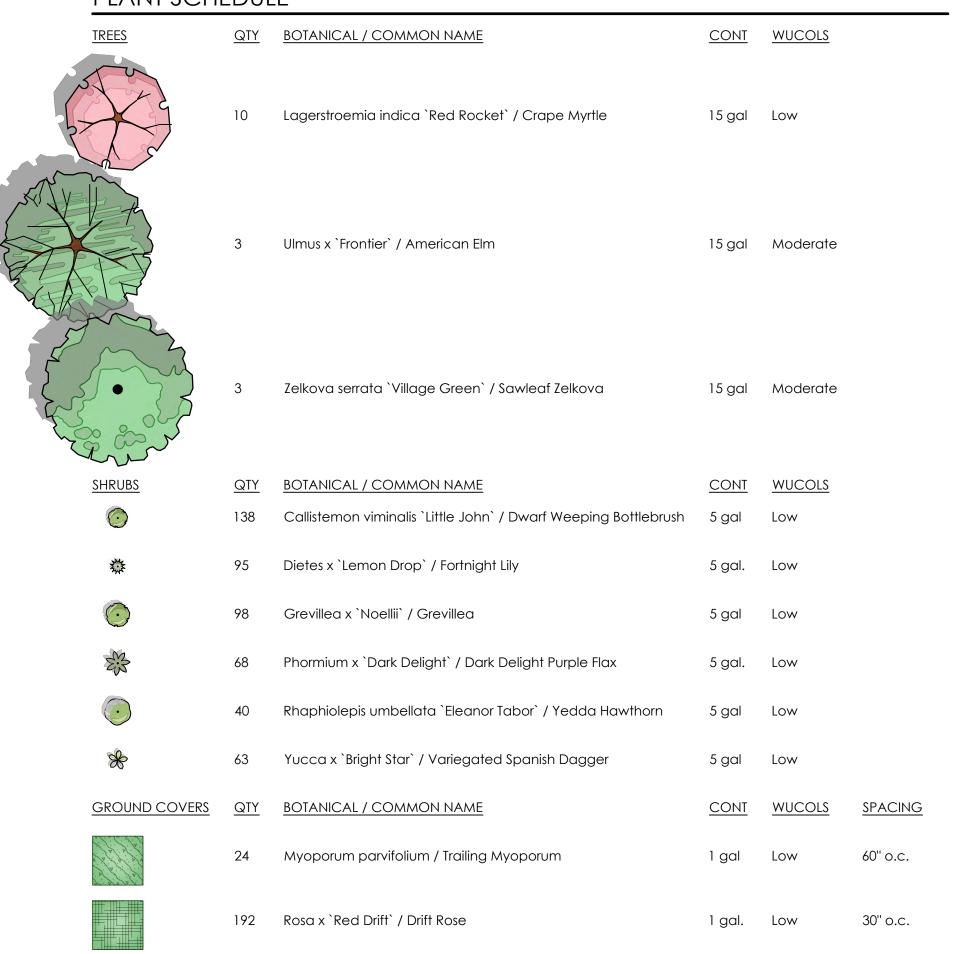


## GENERAL NOTES

- 1. All landscape planting areas shall receive a minimum 3" layer of organic mulch top dressing.
- 2. All trees, shrubs and groundcover shall be irrigated with a drip system, smart controller, weather sensor, etc.and shall meet City of Willows Water Efficient standards/regulations.
- 3. All new trees located within 7' of pavement or permanent structure shall have a root barrier.

## COMPLIANCE STATEMENT

I have complied with the criteria of the water use ordinance and applied them accordingly for the efficient use of water in the landscape design plan.



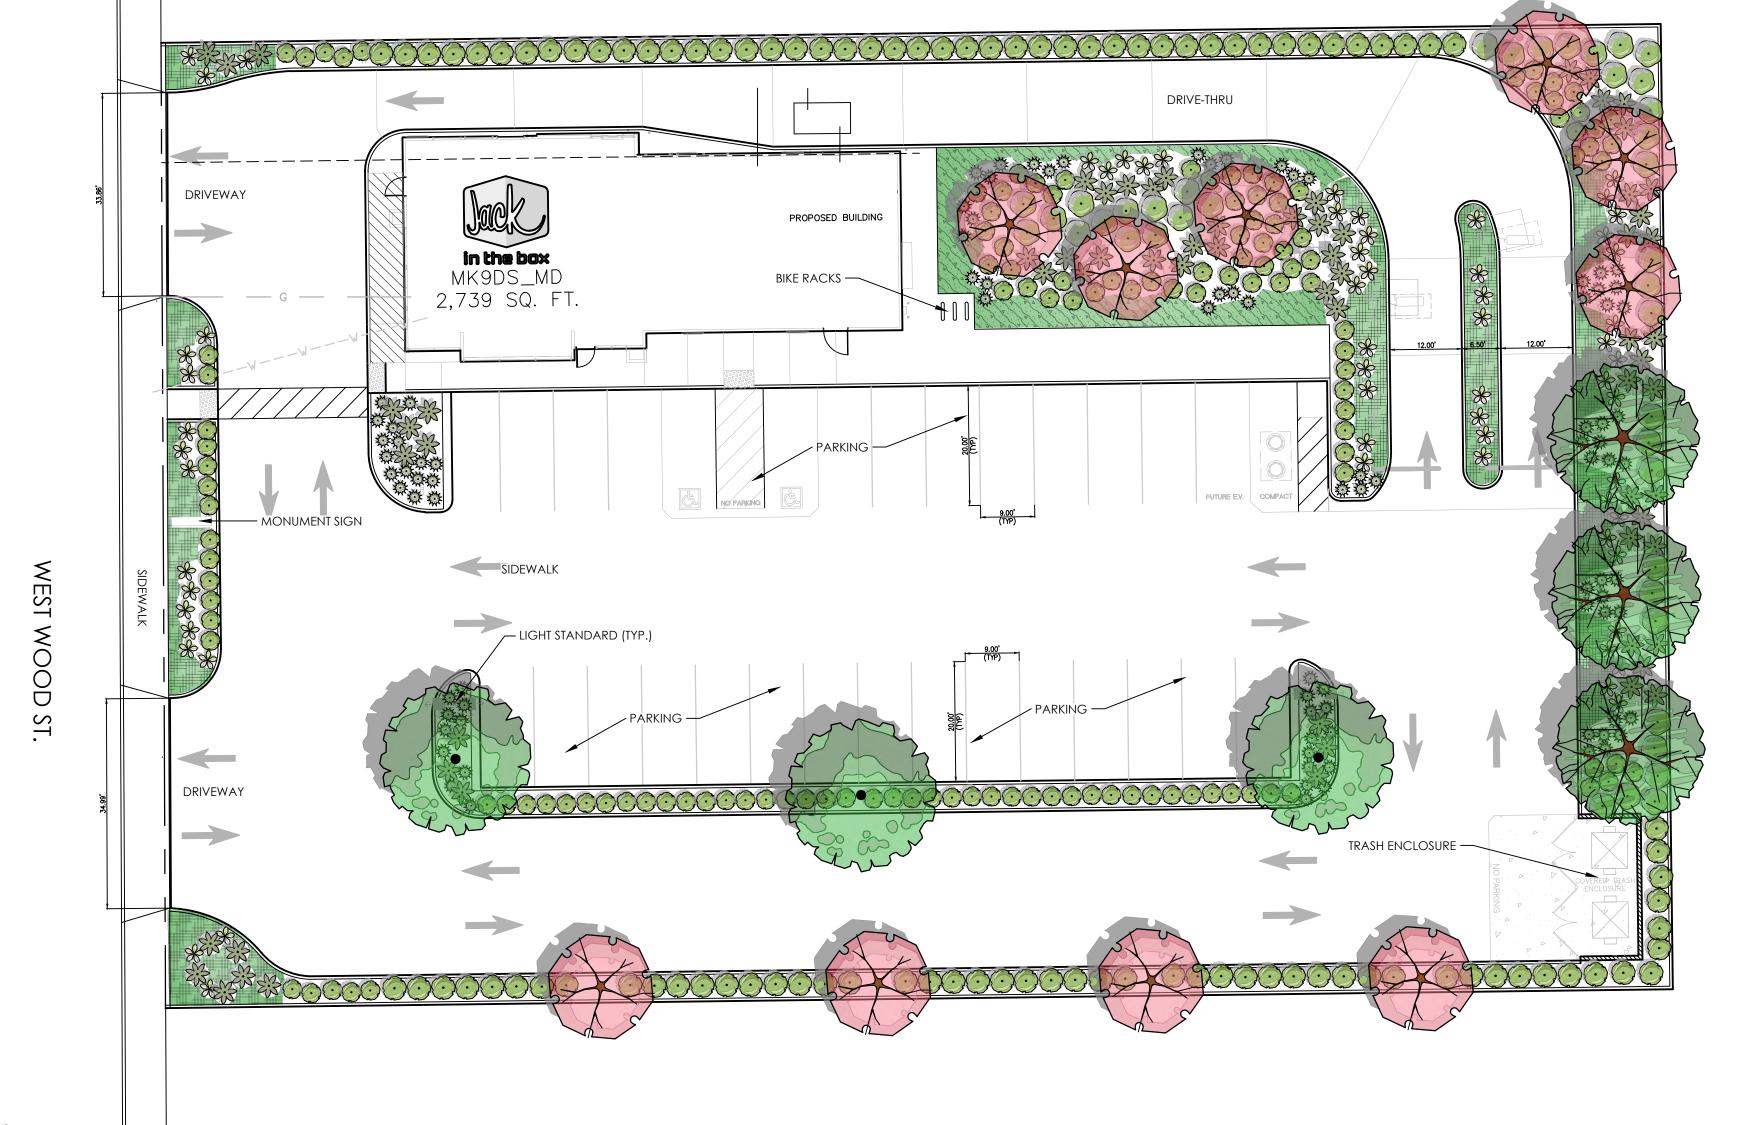

## Water Efficient Landscape Worksheet

HYDROZONE/PLANTING DESCRIPTION	PLANT FACTOR (PF)	IRRIG. METHOD	IRRIG. EFFICIENCY (IE)	ETAF (PF/IE)	LANDSCAPE AREA (Sq. Ft.)	ETAF x AREA	ESTIMATED TOTAL WATER USE (ETWU)
REGULAR LANDSCAPE AREA	·						
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				TOTALS	(A) 8,430	(B)3,151	
					E	TWU Total	100,221GAL.

Maximum Applied Water Allowance (MAWA). MAWA= (ETo) (Conversion factor) ((ETAF)(Landscape Area)) + ((1-ETAF) x SLA) (51.3) (.62) (.45 x 8,430) + (1-.45) X 0) = 120,656 GALLONS

Estimated Total Water use (ETWU). ETWU= (ETO)) (Conversion factor) ((ETAF) (Area))

= 100,221 GALLONS

## ETAF Calculations

Regular Landscape Areas

Total ETAF x Area	(B) 3,151	
Total Area	(A) 8,430	
Average ETAF	(B / A) .37	

 Average ETAF for Regular Landscape Areas must be below .55 for residential areas and .45 for non-residential areas.



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DATES

**RELEASE:** OCT. 02, 2017 **P.M. UPDATES:** <u>SEPT. 27, 2019</u>

SUBMITTAL DATE: **1:** 7/14/21

**CONSTRUCTION:** 

REVISIONS

**OLIVE STREET** LANDSCAPE ARCHITECTURE

P.O. Box 2083 Petaluma CA 94952 707-280-8990 OliveStreetLandscape.com rod@olivestreetlandscape.com





(916) 415-5358 rpedro@pmdginc.com

SUITE 100 ROCKLIN, CA 95677

Roy W. Pedro, Architect

SITE INFORMATION

MK TYPE: MK9DS\_MD JIB #: <u>4387</u>

ADDRESS:

1240 W. WOOD ST. WILLOWS, CA 95988

DRAWN BY:

**PROJECT #:** WFM20001.0 SCALE: 1" = 16'

> LANDSCAPE **PLAN**



## ATTACHMENT 5



**PERMIT** 

ORIGINAL DESIGN: 3/12/21-JMc

in the box

4444 Federal Blvd San Diego, CA 92102

(619) 527-6100 signtech.com


**JACK IN THE BOX** 

Sales: Bob McCarter

**Coordinator:** Thea Tochihara

date: 3/12/21

drawing: J4387-PERMIT rev:XX

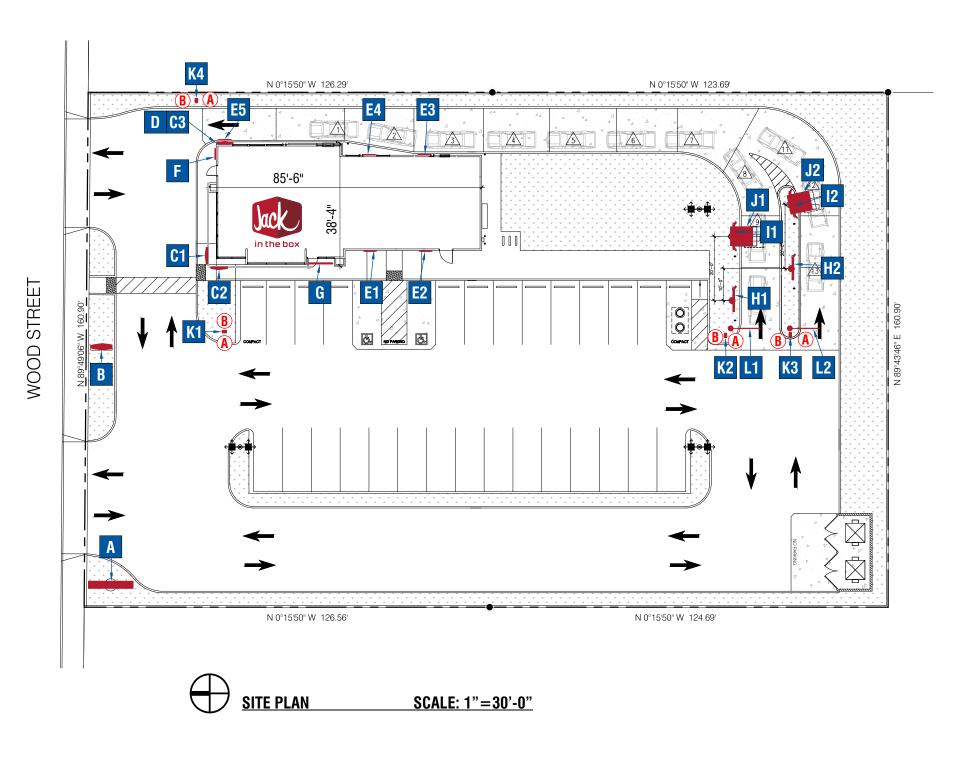

	9	SIGN LEGEND		
SIGN #	DESCRIPTION	SIGN TYPE	SF	QTY
Α	PYLON - DETAILS TBV	JITB-PYL-XXXXX	XX	1
В	J30 MONUMENT SIGN	JITB-MON-J30-96x69	26.6	1
C1	J30 WALL SIGN	JITB-J30	27.76	1
C2	J30 WALL SIGN	JITB-J30	27.76	1
C3	J30 WALL SIGN	JITB-J30	27.76	1
D	J30 WALL SIGN HALO KIT	JITB-J30-HALO KIT	N/A	1
E1	POSTER MARQUEE - SINGLE	JITB-WC-60x49-MARQUEE	20.5	1
E2	POSTER MARQUEE - SINGLE	JITB-WC-60x49-MARQUEE	20.5	1
E3	POSTER MARQUEE - SINGLE	JITB-WC-60x49-MARQUEE	20.5	1
E4	POSTER MARQUEE - SINGLE	JITB-WC-60x49-MARQUEE	20.5	1
E5	POSTER MARQUEE - SINGLE	JITB-WC-57x79-MARQUEE	20.5	1
F	ILLUM. ADDRESS CABINET	JITB-WC-16x42-ADDRESS-1230	4.7	1
G	NEIGHBORHOOD LETTERS	JITB-FCO-AL-8	N/A	1
H1	PREVIEW MENU - BY OTHERS	PREVIEW MENU BY NATIONAL SIGNS	26	1
H2	PREVIEW MENU - BY OTHERS	PREVIEW MENU BY NATIONAL SIGNS	26	1
l1	SPEAKER MENU - BY OTHERS	SPEAKER MENU BY NATIONAL SIGNS	27.1	1
12	SPEAKER MENU - BY OTHERS	SPEAKER MENU BY NATIONAL SIGNS	27.1	1
J1	SPEAKER MENU CANOPY	JITB-CAN-72x84-120	N/A	1
J2	SPEAKER MENU CANOPY	JITB-CAN-72x84-120	N/A	1
K1	DIR. SIGN - "DRIVE-THRU"	JITB-DIR-17x17x48-DRIVETHRU-LEFT/RIGHT	2.3	1
K2	DIR. SIGN - "DRIVE-THRU"	JITB-DIR-17x17x48-DRIVETHRU-LEFT/RIGHT	2.3	1
K3	DIR. SIGN - "DRIVE-THRU"	JITB-DIR-17x17x48-DRIVETHRU-LEFT/RIGHT	2.3	1
K4	DIR. SIGN - "TY/DNE"	JITB-DIR-17x17x48-THANKYOU/DONOTENTER	2.3	1
L1	HEIGHT DETECTOR	JITB-H-BAR-120	N/A	1
L2	HEIGHT DETECTOR	JITB-H-BAR-120	N/A	1



**JACK IN THE BOX** 

1230 W Wood St Willows, CA 95988 USA


**Engineering:** 

Design: JMc

drawing: J4387-PERMIT rev:XX


quote: project ID: JIB\_4387\_2

date: 3/12/21

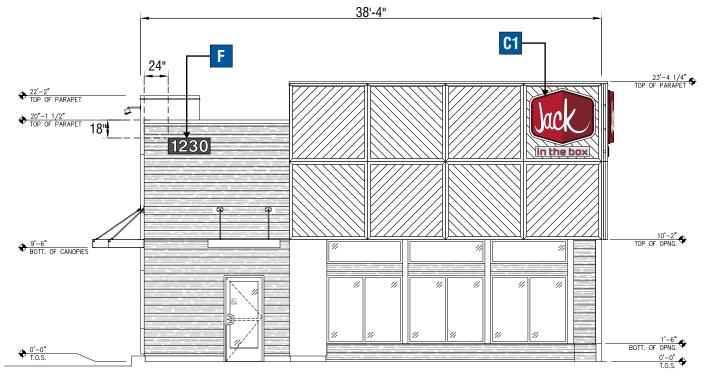

**NORTH / FRONT ELEVATION** 

**SCALE:** 1/8"=1'-0"

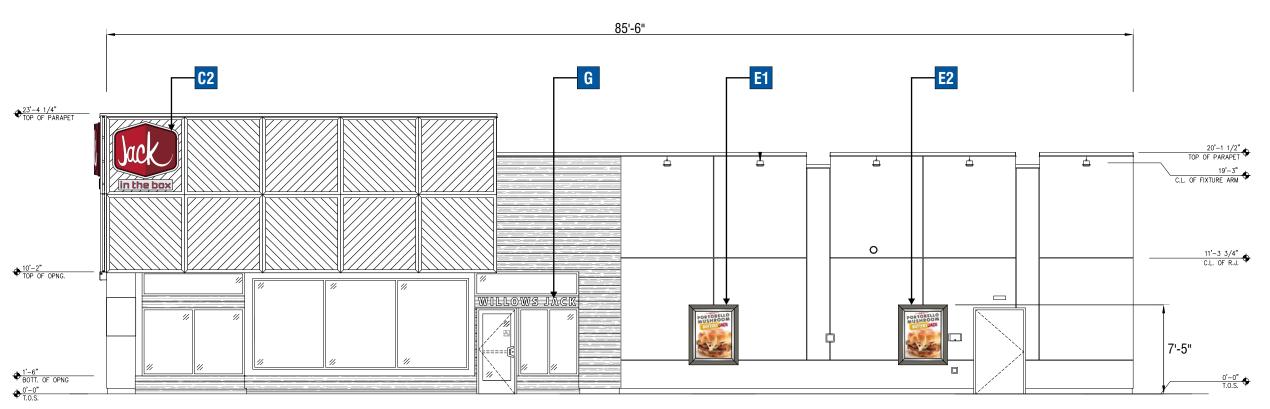

**WEST / RIGHT ELEVATION** 


SCALE: 1/8"=1'-0"




**Engineering:** 

date: 3/12/21 drawing: J4387-PERMIT rev:XX

quote: project ID: JIB\_4387\_2

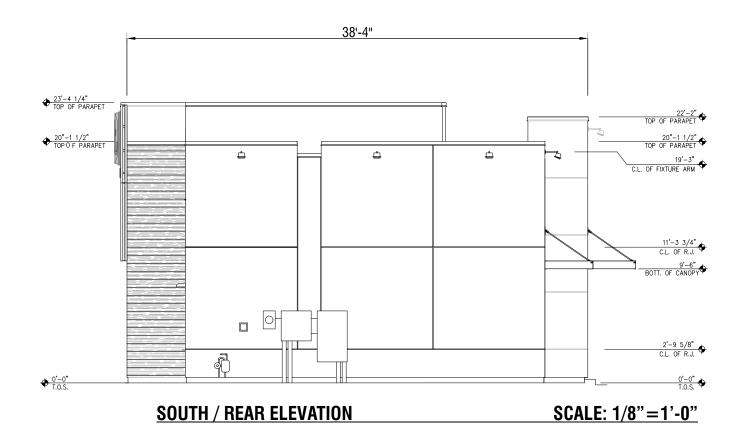

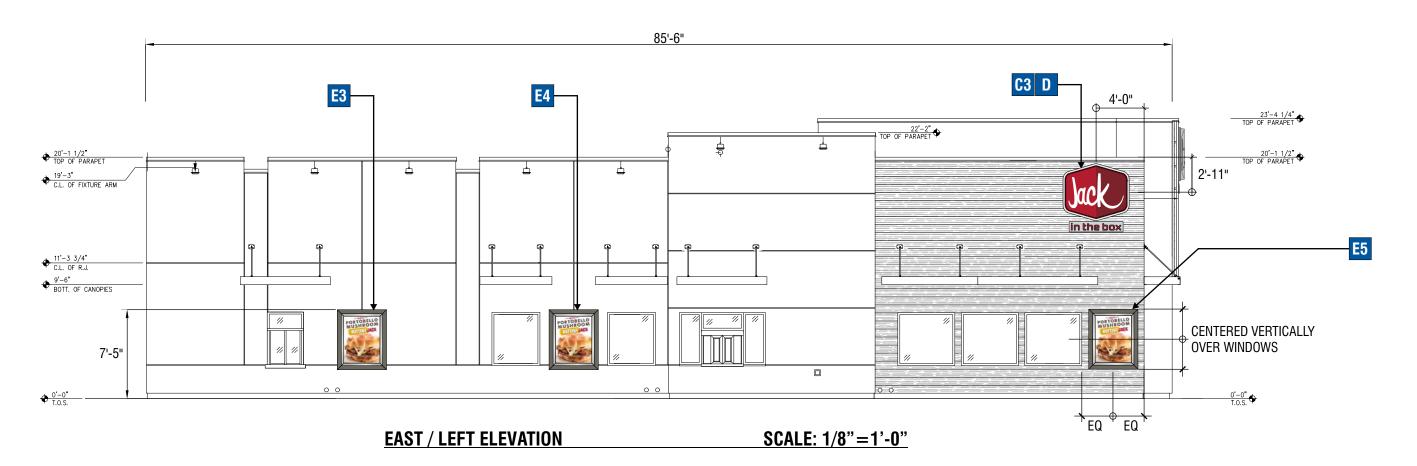




**JACK IN THE BOX** 

J4387 1230 W Wood St Willows, CA 95988 USA Sales: Bob McCarter
Coordinator: Thea Tochihara
Design: JMc

**Engineering:** 

date: 3/12/21 drawing: J4387-PERMIT rev:XX

quote: project ID: JIB\_4387\_2

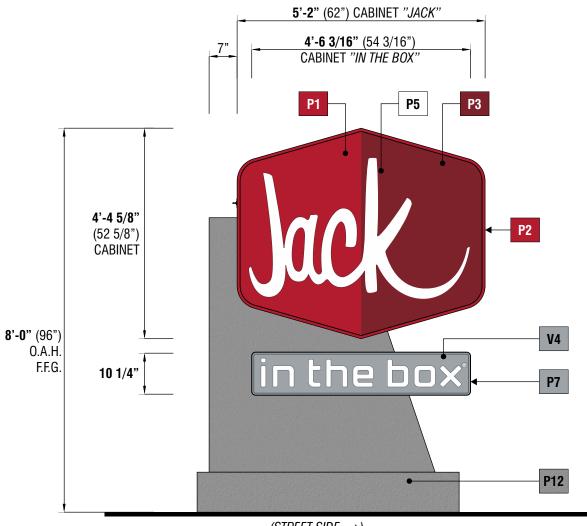

BASE in the box°

 $(STREET\ SIDE \longrightarrow)$ 

SIDE A SCALE: 1/2"=1'-0"

> UPPER CABINET: 22.7 SQ. FT. LOWER CABINET: 3.9 SQ. FT. TOTAL: 26.6 SQ. FT.

B SIGNTYPE JITB-MON-J30-96x69

MANUFACTURE AND INSTALL ONE (1) D/F INTERNALLY ILLUMINATED J30 MONUMENT SIGN

4444 Federal Blvd San Diego, CA 92102

(619) 527-6100 signtech.com

**UPPER CABINET:** FABRICATED ALUMINUM WITH INTERNAL LED ILLUMINATION **LOWER CABINET:** FABRICATED ALUMINUM WITH INTERNAL LED ILLUMINATION

**FACES:** FORMED LEXAN WITH SECOND SURFACE GRAPHICS

**BASE:** FABRICATED ALUMINUM

**ILLUMINATION: LED - SLOAN PRISM 5700K WHITE** 

SIDE B

TO MATCH LACRYL SERIES 400 LW-5-9404-1 TRANSLUCENT PAINT

SCALE: 1/2"=1'-0"

- TO MATCH MP 64691 'JIB RED' OPAQUE PAINT
- TO MATCH LACRYL SERIES 400 443 'DEEP RED' *TRANSLUCENT PAINT*
- TO MATCH LACRYL SERIES 400 L-403-W *TRANSLUCENT PAINT*
- TO MATCH MP 02065 'SLATE GRAY
- TO MATCH SHERWIN WILLIAMS SW7018 'DOVETAIL' W/ SATIN FINISH AND MEDIUM TEXCOTE

VINYL

3M 3630-61 'SLATE GRAY'

#### **JACK IN THE BOX**

1230 W Wood St Willows, CA 95988 USA

Sales: Bob McCarter **Coordinator:** Thea Tochihara

**Engineering:** 

Design: JMc

date: 3/12/21

drawing: J4387-PERMIT rev:XX

quote: project ID: JIB\_4387\_2


**END VIEW SCALE: 1/2"=1'-0"** 

1'-3"

CABINET

1'- 0 1/2"



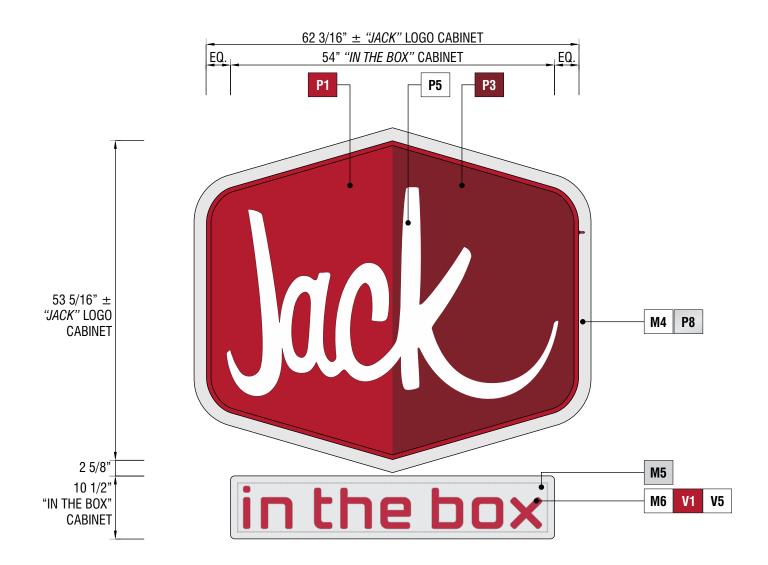

FRONT VIEW SCALE: 3/4"=1'-0" 27.76 SQ. FT.



MANUFACTURE AND INSTALL THREE (3) S/F INTERNALLY ILLUMINATED J30 WALL SIGN(S)

UPPER CABINET: FABRICATED ALUMINUM WITH INTERNAL LED ILLUMINATION AND UL APPROVED

DISCONNECT SWITCH

LOWER CABINET: FABRICATED ALUMINUM WITH INTERNAL LED ILLUMINATION **UPPER FACE:** FORMED POLYCARBONATE WITH SECOND SURFACE GRAPHICS

LOWER FACE: ROUTED ACM WITH PUSH-THRU ACRYLIC COPY

LOGO BORDER: ACM **ILLUMINATION: LED** 


#### **MATERIALS**

3 1/2" CHANNEL LETTER COIL PRE-COATED MP 64691 "JIB RED" WITH SATIN FINISH

**M4** 3MM WHITE ACM (0.118" SKIN)

**M5** 3MM SILVER ACM (0.118" SKIN)

M6 3/4" CLEAR ACRYLIC

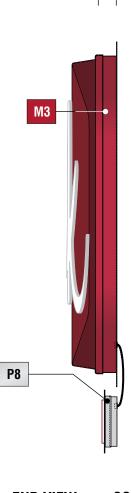

3" CABINET |

#### **END VIEW** SCALE: 3/4"=1'-0"

TO MATCH LACRYL SERIES 400 LW-5-9404-1 TRANSLUCENT PAINT

TO MATCH LACRYL SERIES 400 443 'DEEP RED' *TRANSLUCENT PAINT* 

TO MATCH LACRYL SERIES 400 L-403-W *TRANSLUCENT PAINT* 

TO MATCH MP 30136 'BRUSHED ALUMINUM'

#### VINYL

3M 3630-73 'DARK RED'

**V5** 3M 3635-70 '60% DIFFUSER'




Design: JMc **Engineering:** 

date: 3/12/21

drawing: J4387-PERMIT rev:XX

quote:

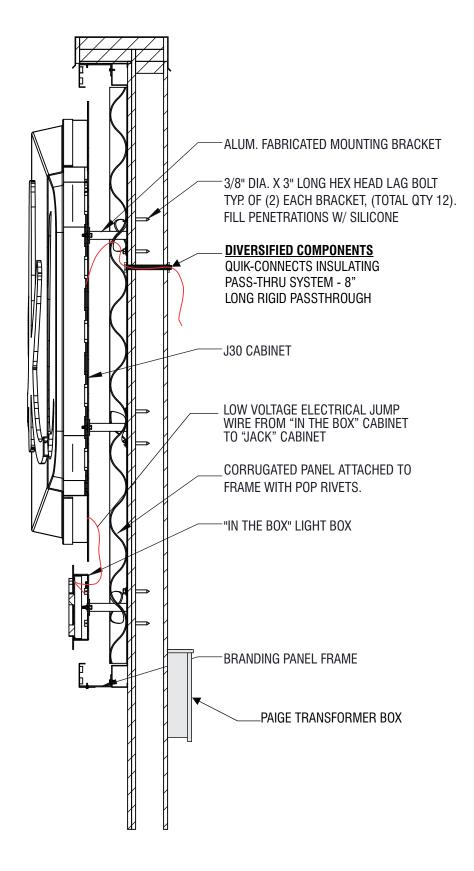



**INSTALLATION VERTICAL SECTION** 

Signtech

Scale: 1" = 1'-0"

4444 Federal Blvd San Diego, CA 92102 (619) 527-6100 signtech.com

#### **JACK IN THE BOX**

**Engineering:** 


Sales: Bob McCarter **Coordinator:** Thea Tochihara

Design: JMc


date: 3/12/21

drawing: J4387-PERMIT rev:XX

quote: project ID: JIB\_4387\_2

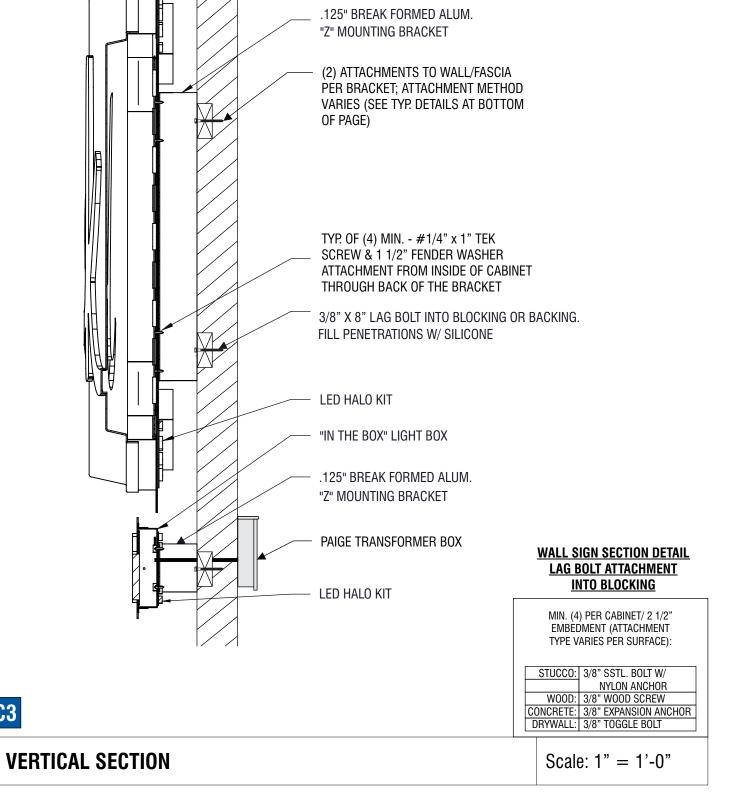

C3

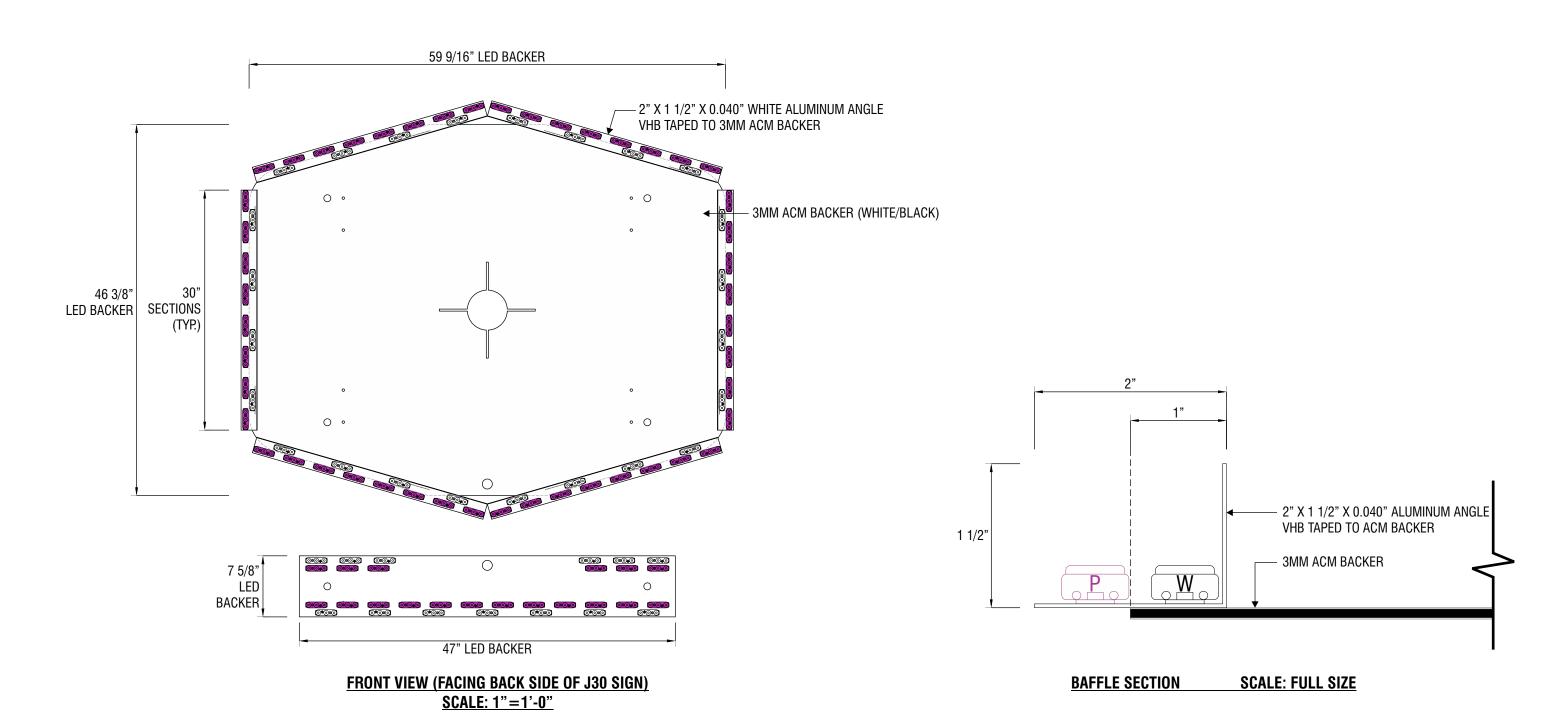



MANUFACTURE AND INSTALL ONE (1) J30 LED HALO KIT

BACKER: 3MM ACM (WHITE/BLACK)

BAFFLE: 2" X 1 1/2" X 0.040" PRE-COATED WHITE ALUMINUM ANGLE

**ILLUMINATION:** WHITE AND PURPLE LED


Signtech

Sales: Bob McCarter Coordinator: Thea Tochihara Design: JMc

**Engineering:** 

**date:** 3/12/21

drawing: J4387-PERMIT rev:XX quote:

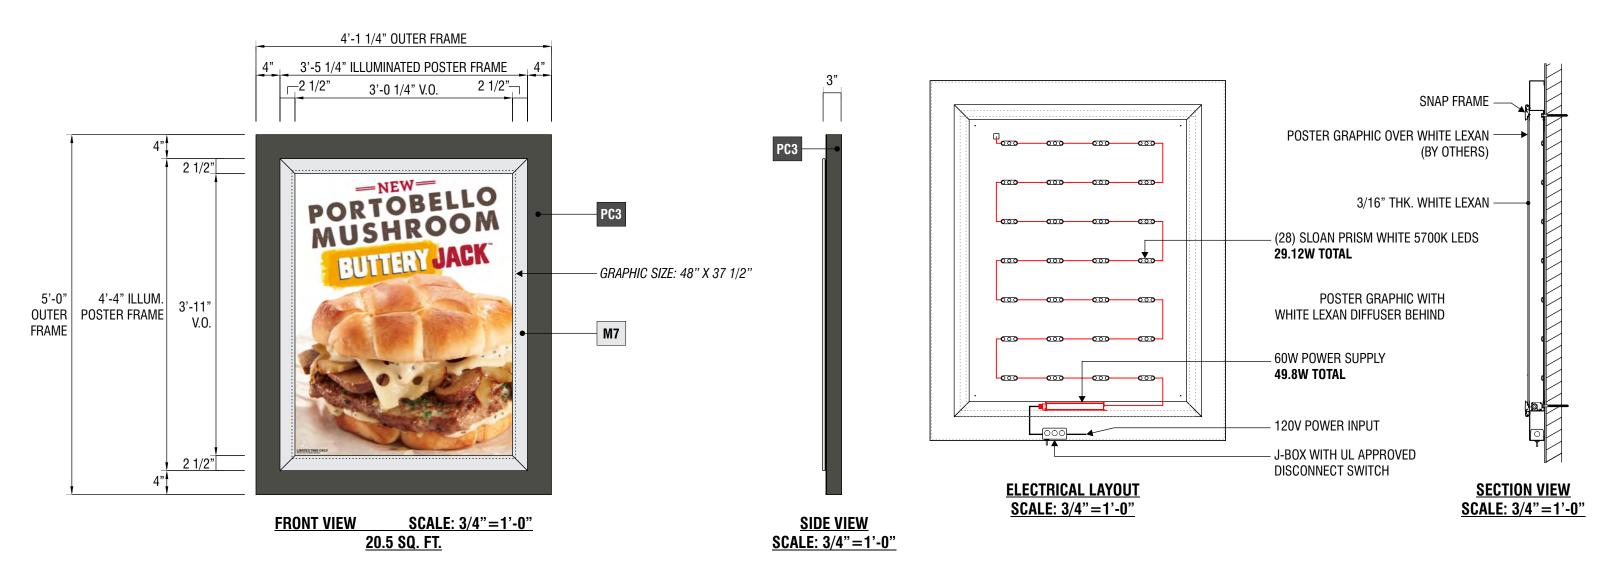

E1 E2 E3 E4 E5 SIGNTYPE JITB-WC-60x49-MARQUEE

MANUFACTURE AND INSTALL FIVE (5) ILLUMINATED SINGLE POSTER MARQUEE PANEL(S)

FACE: ROUTED 3/16" WHITE LEXAN WITH ATTACHED SNAP FRAME. INSERTS BY OTHERS **OUTER FRAME: FABRICATED .063" THICK ALUMINUM** 


ILLUMINATION: INTERNAL LED ILLUMINATION AND UL APPROVED DISCONNECT SWITCH

#### **POWDER COAT**

TO MATCH RAL7022 W/ SATIN FINISH 'UMBRA GREY'

#### **MATERIALS**

M7 ALUMINUM SNAP FRAME W/ CLEAR ANODIZED SATIN FINISH

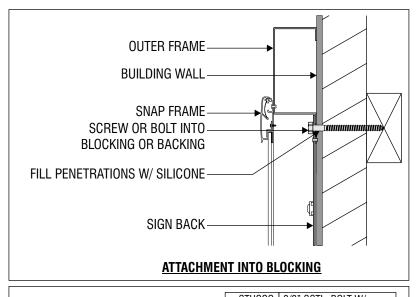

MIN. (4) PER CABINET/ 2 1/2"
EMBEDMENT (ATTACHMENT
TYPE VARIES PER SURFACE):
== . =

STUCCO:	3/8" SSTL. BOLT W/
	NYLON ANCHOR
WOOD:	3/8" WOOD SCREW
CONCRETE:	3/8" EXPANSION ANCHOR
DRYWALL:	3/8" TOGGLE BOLT



**JACK IN THE BOX** 


1230 W Wood St Willows, CA 95988 USA

**Engineering:** 

**Coordinator:** Thea Tochihara Design: JMc

quote:

date: 3/12/21 drawing: J4387-PERMIT rev:XX

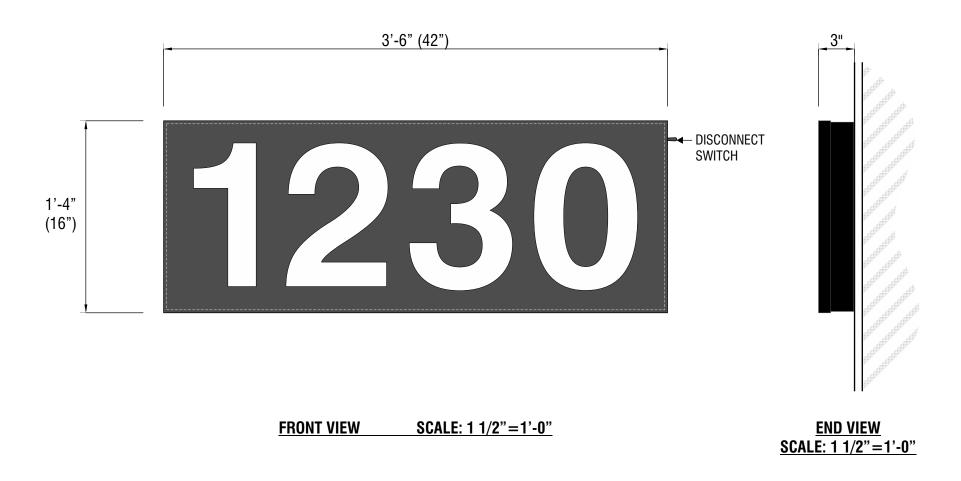

F SIGNTYPE JITB-WC-16x42-ADDRESS-1230

## MANUFACTURE AND INSTALL ONE (1) PLEX FACE INTERNALLY ILLUMINATED ADDRESS CHANNEL LETTER

FACE: .177" THICK #7328 WHITE ACRYLIC WITH 3M NIMBUS GREY 101 (GERBER 220-41) ON FIRST SURFACE.


**TRIMCAP:** 1" BLACK JEWELITE

RETURNS: .040" x 3" DEEP PRE-PAINTED SATIN BLACK ALUM. COIL.

BACKS: .050" PRE-PAINTED WHITE ALUM.

**ILLUMINATION: PRINCIPAL QWIK MOD 3 6500K WHITE** 

STUCCO: 1/4" SSTL. BOLT W/ NYLON ANCHOR WOOD: 1/4" LAG WOOD SCREW CONCRETE: 1/4" EXPANSION ANCHOR DRYWALL: 1/4" TOGGLER BOLT

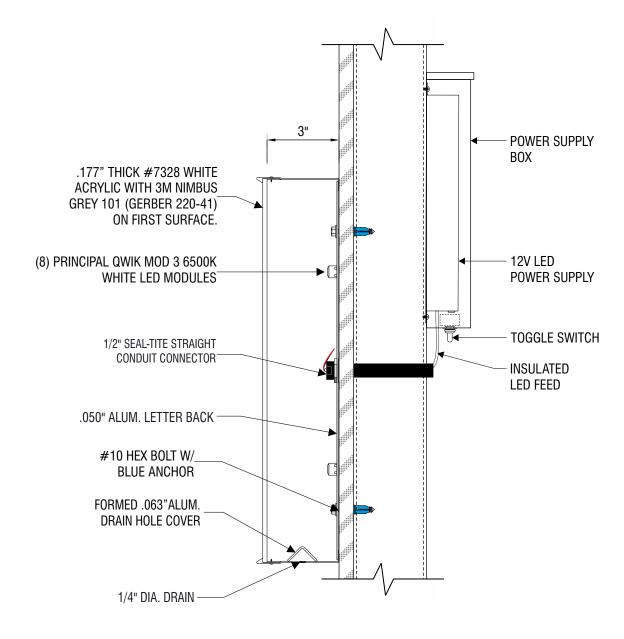

SCALE: 3"=1'-0" **SECTION VIEW** 



JACK IN THE BOX

1230 W Wood St Willows, CA 95988 USA


**Engineering:** 

Sales: Bob McCarter

date: 3/12/21

drawing: J4387-PERMIT rev:XX quote:

#### REMOVE NOTES AFTER ADJUSTMENT

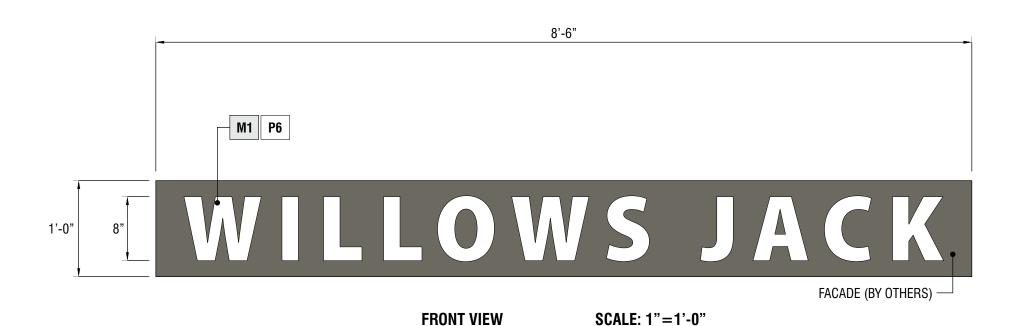

10-24 X 1 1/2" ALUMINUM STUD POP WELDED TO BACK OF LETTER 1/8" ALUMINUM LETTER SILICONE-1/2" ANODIZED SILVER STANDOFFS

> **SECTION VIEW SCALE: HALF SIZE**

G SIGNTYPE JITB-FCO-AL-8

MANUFACTURE AND INSTALL ONE (1) SET OF NON-ILLUMINATED WALL MOUNTED FCO NEIGHBORHOOD SIGN LETTERS

**PAINT** P6 POWDER COAT WHITE - SATIN FINISH **MATERIALS M1** 1/8" ALUMINUM



**JACK IN THE BOX** 

1230 W Wood St Willows, CA 95988 USA


Sales: Bob McCarter **Coordinator:** Thea Tochihara

Design: JMc **Engineering:** 

date: 3/12/21


drawing: J4387-PERMIT rev:XX


quote:

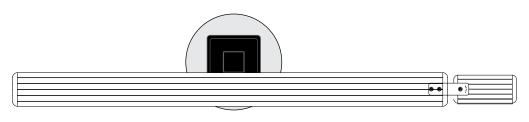

**PLAN VIEW** SCALE: 1/2"=1'-0"

7'-5 5/8"

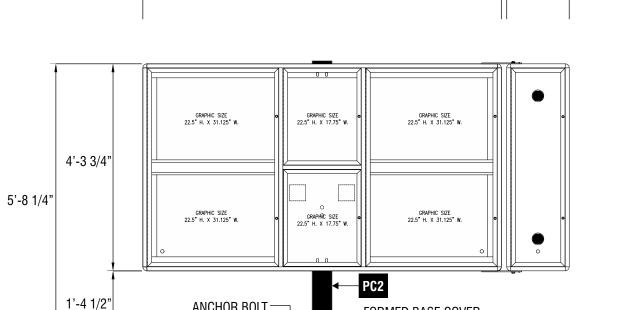

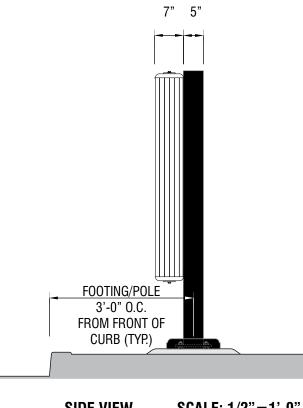

SCALE: 1/2"=1'-0" **FRONT VIEW** 

FORMED BASE COVER

**REAR VIEW** SCALE: 1/2"=1'-0"

SCALE: 1/2"=1'-0" **SIDE VIEW** 



ANCHOR BOLT


FOOTING BY G.C.

#### INSTALL ONE (1) PREVIEW MENU BY OTHERS WITH BREAKFAST EXTENDER

**CABINET:** MANUFACTURED BY NATIONAL SIGNS **POLE:** 5" STEEL SQUARE TUBE

**POWDER COAT** 



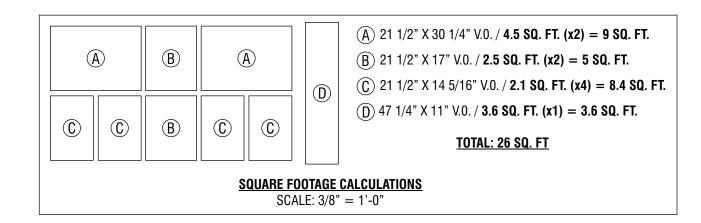




**JACK IN THE BOX** 

1230 W Wood St Willows, CA 95988 USA


Sales: Bob McCarter **Coordinator:** Thea Tochihara Design: JMc

**Engineering:** 

date: 3/12/21 drawing: J4387-PERMIT rev:XX quote:

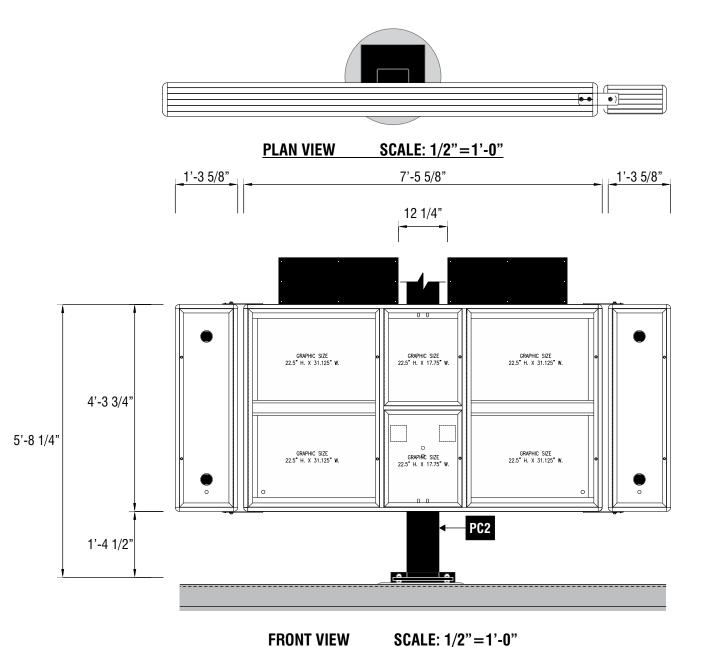

NOTE: MENU LUG-ON HARDWARE MUST BE SPACED CORRECTLY FOR GRAPHICS TO FIT.

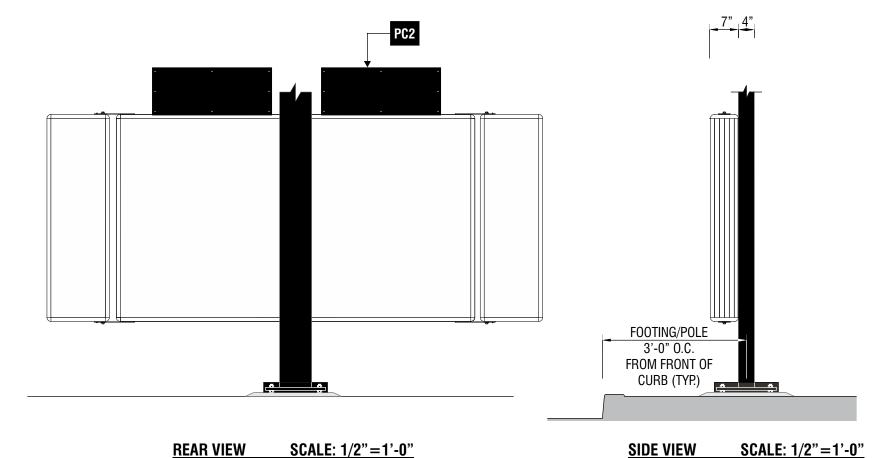

I1 I2 SIGNTYPE SPEAKER MENU BY OTHERS


INSTALL ONE (1) SPEAKER MENU BY OTHERS WITH BREAKFAST & LATE NIGHT EXTENDERS BY OTHERS AND MENU LUG-ON HARDWARE PANELS BY OTHERS

**CABINET:** MANUFACTURED BY NATIONAL SIGNS

**POLE:** 4"x8" STEEL RECTANGULAR TUBE (SEE MENU CANOPY)



PC2 TO MATCH RAL 9004 'SIGNAL BLACK' W/ SATIN FINISH

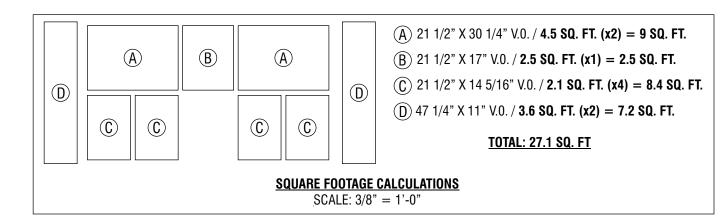




JACK IN THE BOX

J4387 1230 W Wood St Willows, CA 95988 USA Sales: Bob McCarter
Coordinator: Thea Tochihara
Design: JMc

**Engineering:** 

er date: 3/12/21
ara drawing: J4387-PERMIT rev:XX
quote:

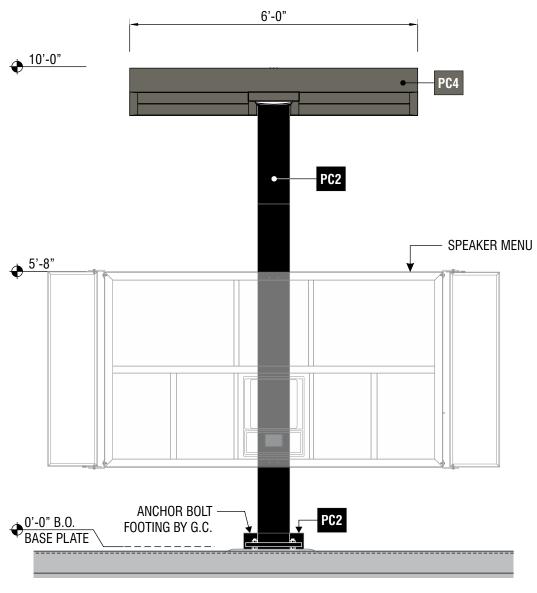


FRONT VIEW SCALE: 1/2"=1'-0"



#### MANUFACTURE AND INSTALL ONE (1) MENU WEATHER CANOPY

**CANOPY:** ALUMINUM RECT. TUBE FRAME WITH ALUMINUM ROOF AND ALUMINUM LAMP ENCLOSURE

**POLE:** 4"x8" STEEL RECTANGULAR TUBE W/ FABRICATED ALUMINUM BASE COVER **ILLUMINATION:** LED LAMP; COLOR TEMP: 5000K; WATTAGE: 42; LUMEN OUTPUT: 5003

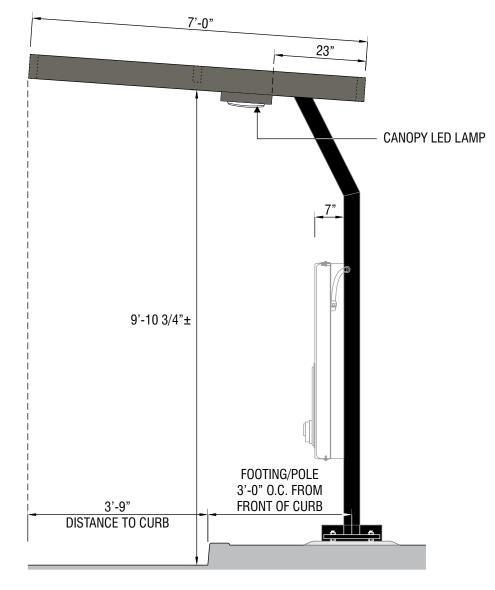

**SIDE VIEW SCALE:** 1/2"=1'-0"

#### POWDER COAT

PC2 TO MATCH RAL 9004 'SIGNAL BLACK' W/ SATIN FINISH

TO MATCH RAL7039 W/ SATIN FINISH 'QUARTZ GREY'



**JACK IN THE BOX** 


J4387 1230 W Wood St Willows, CA 95988 USA Sales: Bob McCarter Coordinator: Thea Tochihara Design: JMc

**Engineering:** 

date: 3/12/21 drawing: J4387-PERMIT rev:XX quote:

project ID: JIB\_4387\_2

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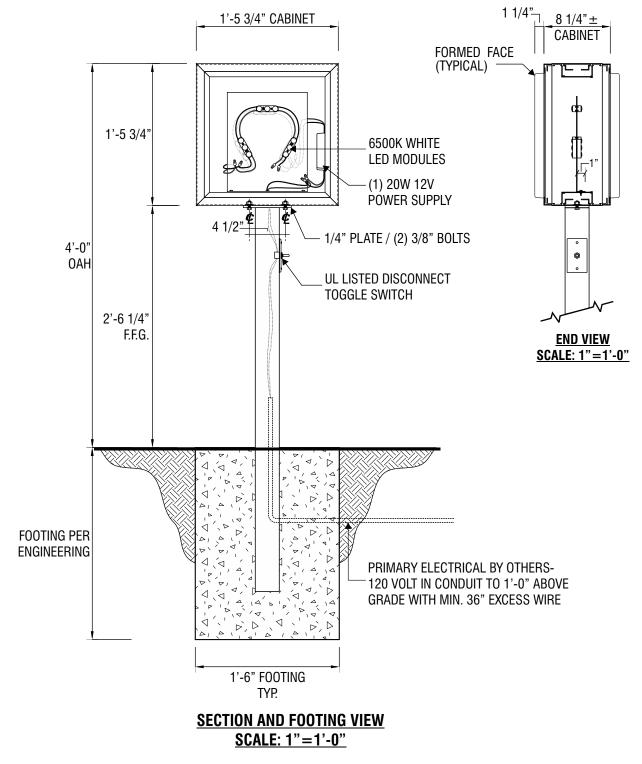
K1 K2 K3 SIGNTYPE JITB-DIR-17x17x48-DRIVETHRU-LEFT/RIGHT
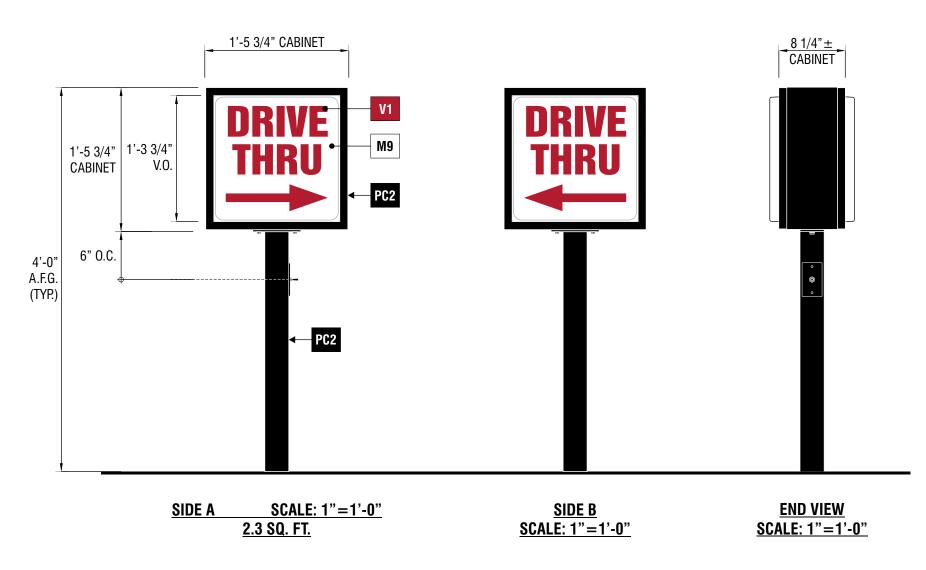
#### MANUFACTURE AND INSTALL THREE (3) D/F INTERNALLY ILLUMINATED DIRECTIONAL SIGN(S)

**CABINET: EXTRUDED ALUMINUM** POLE: 3"x3" STEEL SQUARE TUBE

**ILLUMINATION:** LED - PRINCIPAL QWIK MOD 3 6500K WHITE








Sales: Bob McCarter **Coordinator:** Thea Tochihara Design: JMc

date: 3/12/21 drawing: J4387-PERMIT rev:XX

quote: project ID: JIB\_4387\_2 **Engineering:** 



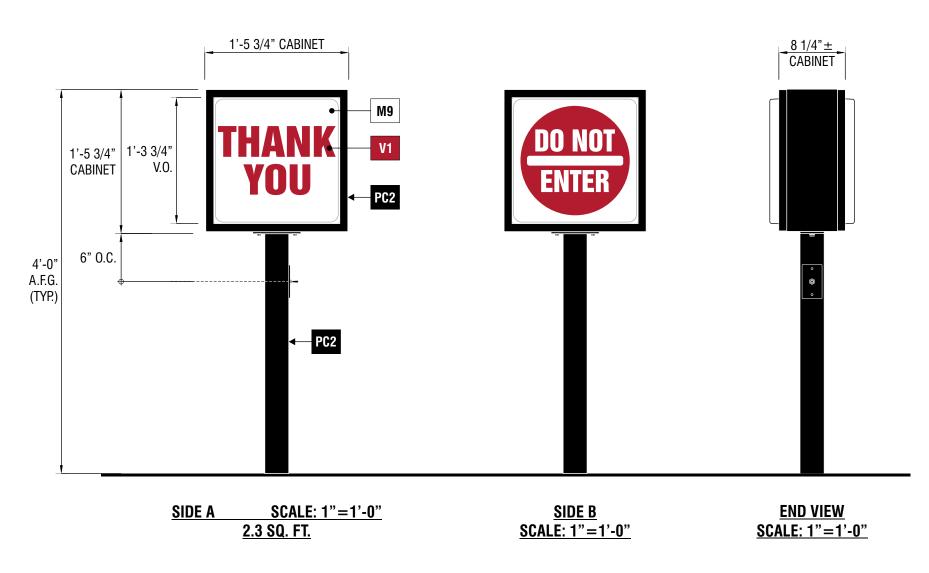


K4 SIGNTYPE JITB-DIR-17x17x48-THANKYOU/DONOTENTER

#### MANUFACTURE AND INSTALL ONE (1) D/F INTERNALLY ILLUMINATED DIRECTIONAL SIGN(S)

**CABINET:** EXTRUDED ALUMINUM **POLE:** 3"x3" STEEL SQUARE TUBE

**ILLUMINATION: LED - PRINCIPAL QWIK MOD 3 6500K WHITE** 



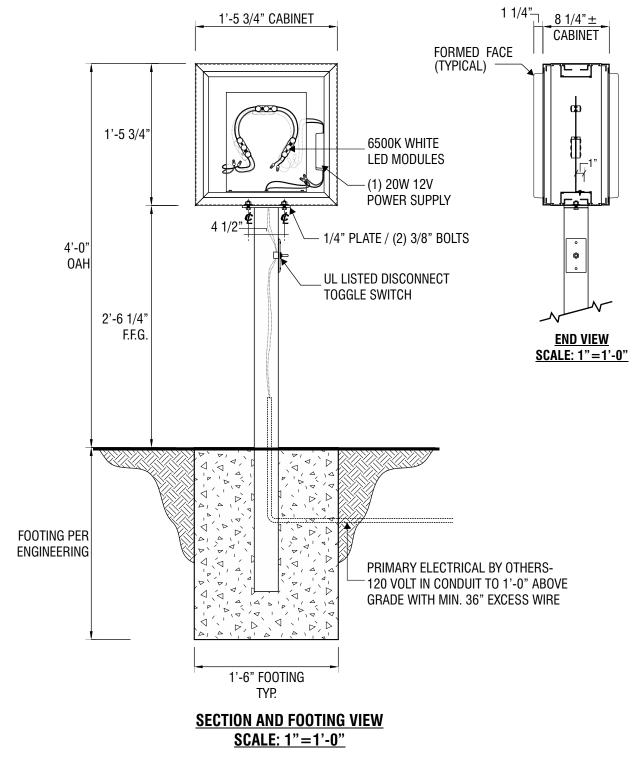



J4387 1230 W Wood St Willows, CA 95988 USA Sales: Bob McCarter Coordinator: Thea Tochihara Design: JMc


**Engineering:** 


date: 3/12/21

drawing: J4387-PERMIT rev:XX

quote: project ID: JIB\_4387\_2



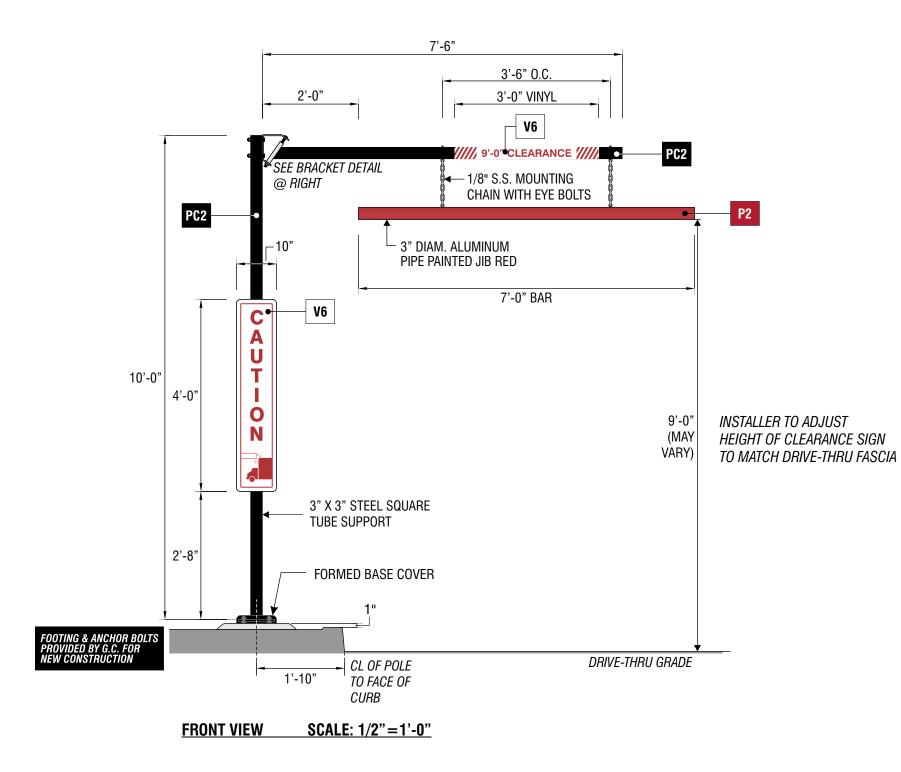

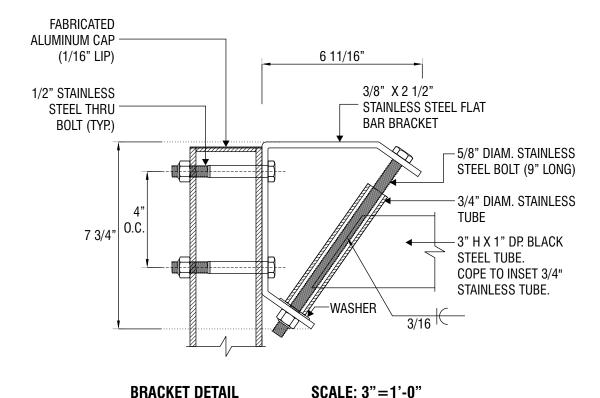

#### **POWDER COAT**

PC2 TO MATCH RAL 9004 'SIGNAL BLACK' W/ SATIN FINISH



TO MATCH MP 64691 'JIB RED' P2 W/ SATIN FINISH

#### VINYL

3M WHITE REFLECTIVE VINYL (680-10) W/ PMS 200 PRINTED COPY

# L1 L2 SIGNTYPE JITB-H-BAR-120

### MANUFACTURE AND INSTALL ONE (1) HEIGHT DETECTOR

**POLE:** 3"x3" STEEL SQUARE TUBE ARM: 3"x1" STEEL RECTANGULAR TUBE

POLE 'CAUTION' PANEL: .063" PRE-COATED WHITE ALUMINUM

4444 Federal Blvd San Diego, CA 92102 (619) 527-6100 signtech.com



#### **JACK IN THE BOX**

**Engineering:** 

quote: project ID: JIB\_4387\_2

drawing: J4387-PERMIT rev:XX

date: 3/12/21


## **ZONING & GENERAL PLAN MAP**

RP: RESIDENTIAL/PROFESSIONAL

HIGHWAY COMMERCIAL

ENTRYWAY



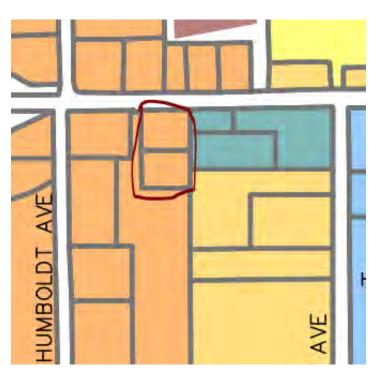

**ZONING DESIGNATION**